# ST.PATRICK STREET PEDWAY RENOVATION AND ELEVATOR ADDITION

ST. PATRICK STREET SAINT JOHN, NEW BRUNSWICK

## ARCHITECTURAL

#### **COVER SHEET DEMOLITION PLANS** FLOOR PLANS AND PARTITIONS CEILING PLANS AND FLOOR FINISH PLANS EXTERIOR ELEVATIONS AND ROOF PLAN SKYLIGHT REFURBISHMENT **BUILDING SECTIONS** WALL SECTIONS STAIR SECTIONS & DETAILS STAIR DETAILS STAIR DETAILS PLAN DETAILS PLAN DETAILS SECTION DETAILS

SECTION DETAILS

### STRUCTURAL

| S-1 | STRUCTURAL PLANS                |
|-----|---------------------------------|
| S-2 | STRUCTURAL PLANS                |
| S-3 | NEW ELEVATOR AND SECTION DETAIL |
| S-4 | NEW ELEVATOR AND SECTION DETAIL |
| S-5 | NEW ELEVATOR AND SECTION DETAIL |
| S-6 | NEW STAIR SECTION               |
|     |                                 |

**NEW STAIR DETAILS** 


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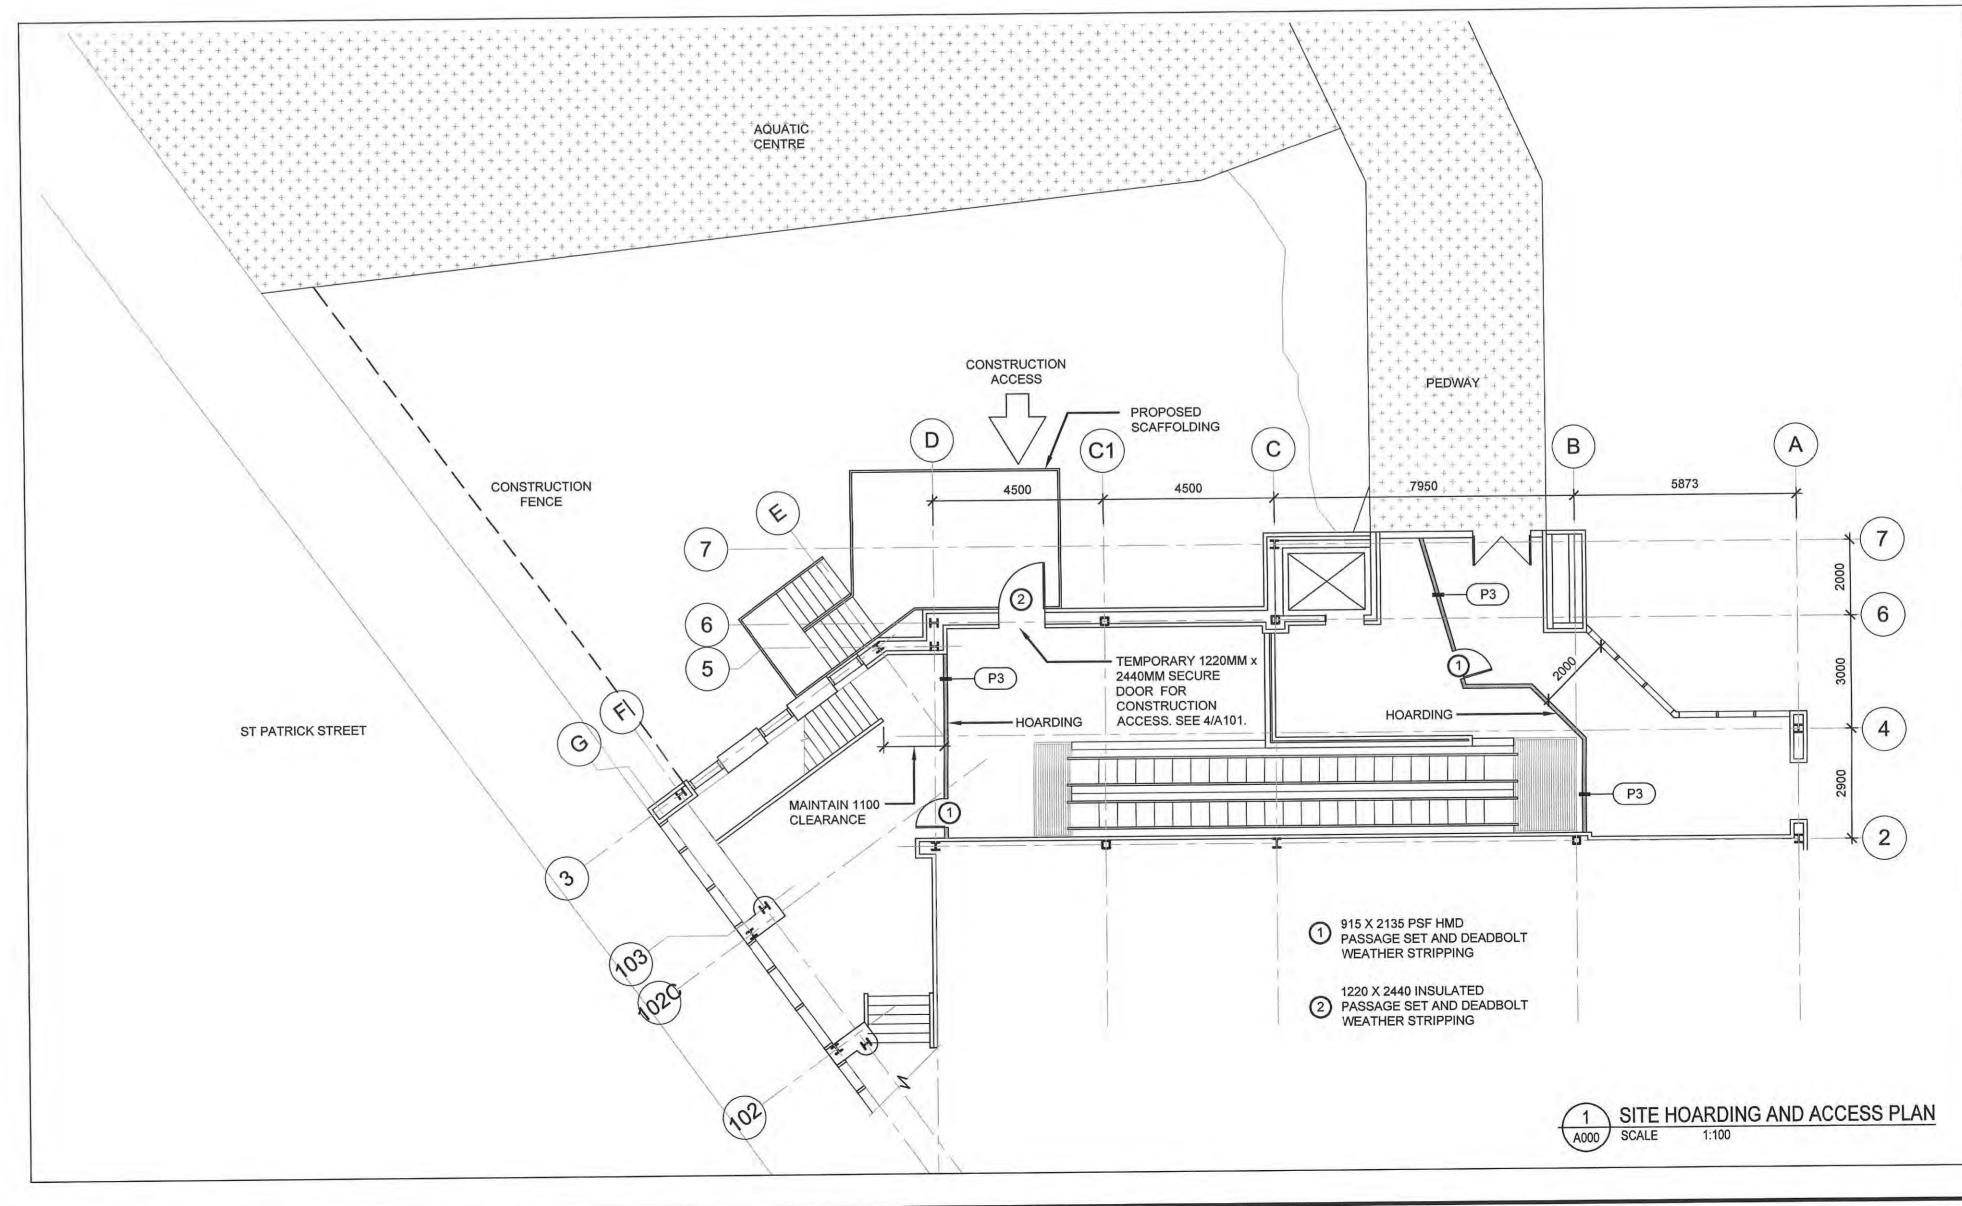
# **MECHANICAL**

| M1 | FLOOR PLANS - FIRE PROTECTION         |
|----|---------------------------------------|
| M2 | FLOOR PLAN - PLUMBING AND VENTILATION |
| M3 | MECHANICAL SPECIFICATIONS             |

#### ELECTRICAL

| E101 | <b>ELECTRICAL DEMOLITION LAYOUTS &amp; LEGEND</b> |
|------|---|
| E102 | <b>ELECTRICAL NEW LAYOUTS &amp; SCHEDULES</b>     |




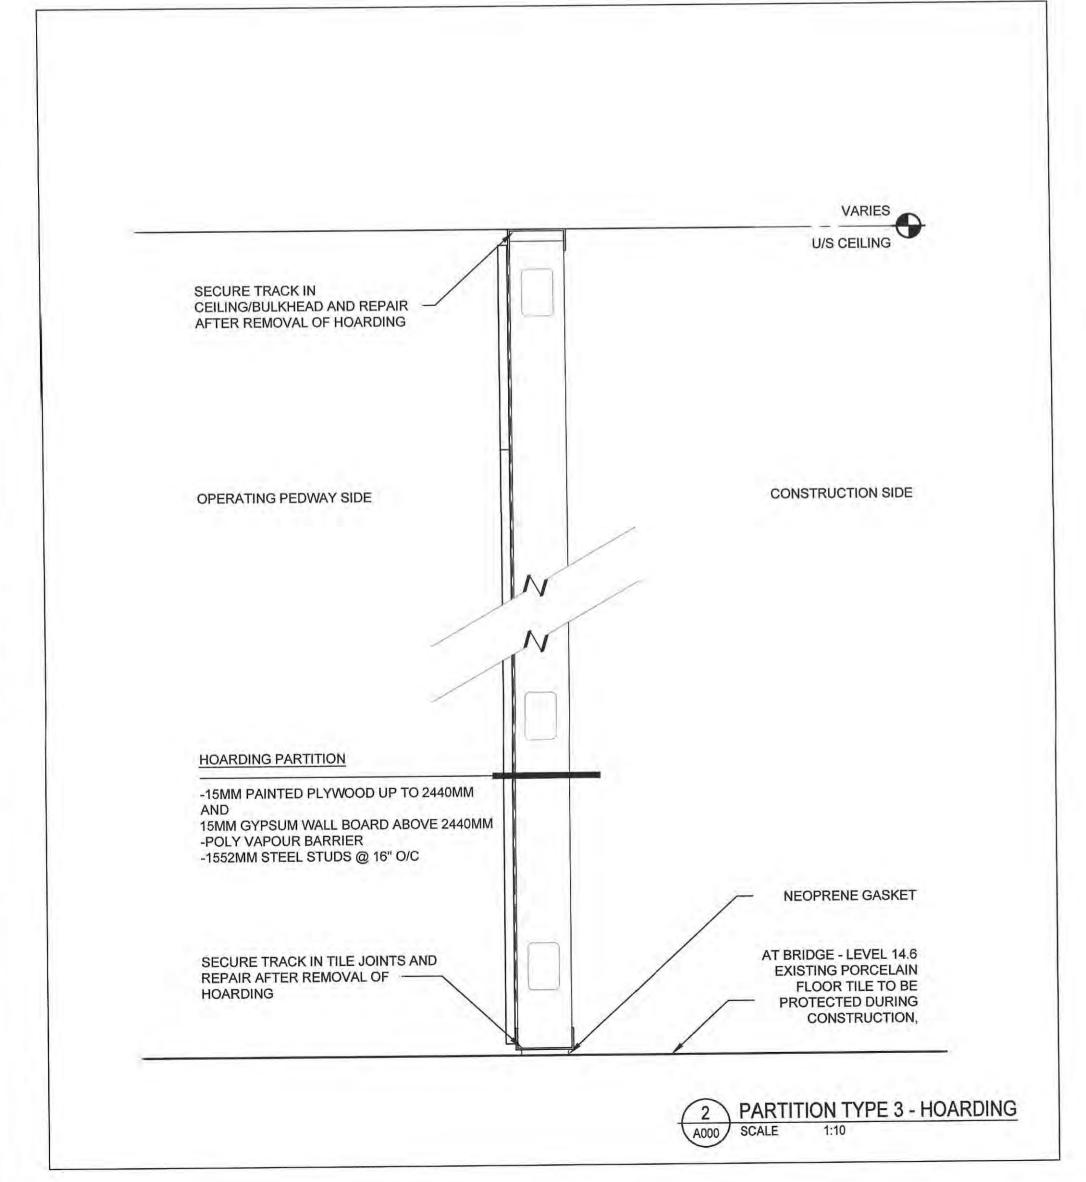





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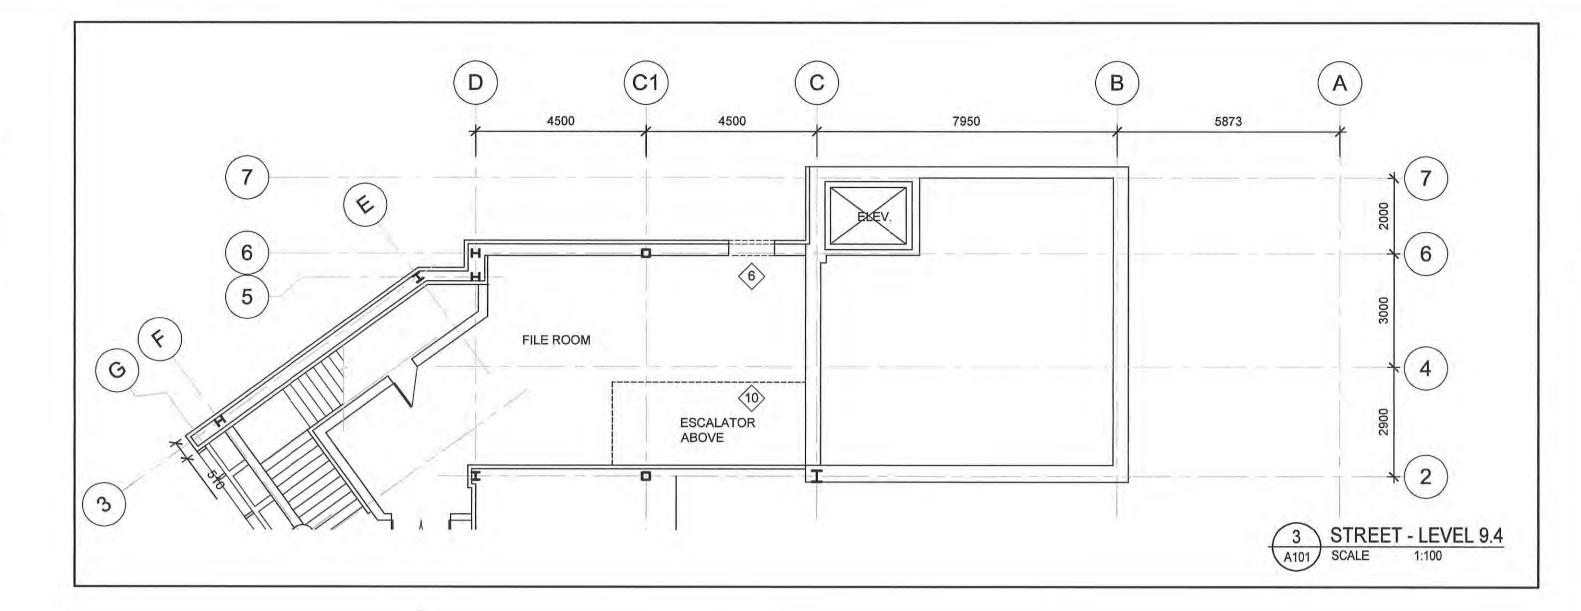


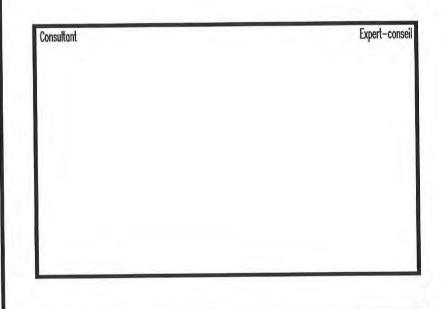
ST. PATRICK STREET PEDWAY **RENOVATION AND ELEVATOR ADDITION** ST. PATRICK STREET SAINT JOHN, NEW BRUNSWICK COVER SHEET AS NOTED

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A000

- REMOVE ESCALATOR, MACHINERY, GRATES, AND ALL ASSOCIATED PARTS.
- NEW OPENINGS IN EXISTING WALLS FOR ACCESS TO ELEVATOR. SEE 2/A501.
- REMOVE EXISTING GUARDRAIL AND BASE. SEE 1/A402FOR DEMOLITION SECTION.
- (4) DEMOLISH WALL BELOW ESCALATOR.
- DEMOLISH BLOCK WALL BELOW ESCALATOR. KEEP BRICK FOR REUSE IN NEW WALL UNDER STAIRS.
- NEW 1220MM X 2135MM OPENING IN BLOCK WALL/CONCRETE WALL FOR ACCESS TO NEW ROOM.
- DEMOLISH PORTION OF WALL FOR 1220MM TEMPORARY DOOR DURING CONSTRUCTION ACCESS. BE PREPARED FOR POSSIBLE CONDUIT IN WALL. SEE 4/A101, 5/A101 AND 7/A101 FOR LINTEL DETAIL.
- (8) REMOVE EXISTING GYPSUM BOARD CEILING.
- OPENINGS TO BE MADE FOR DRAINAGE FROM NEW ELEVATOR TO EXISTING ELEVATOR. SEE STRUCTURAL.
- REMOVE EXISTING GYPSUM BOARD CEILING OF FILE ROOM AS REQUIRED TO ACCESS AND DEMOLISH ESCALATOR. CEILING TO BE REPAIRED DURING CONSTRUCTION SEE A110.




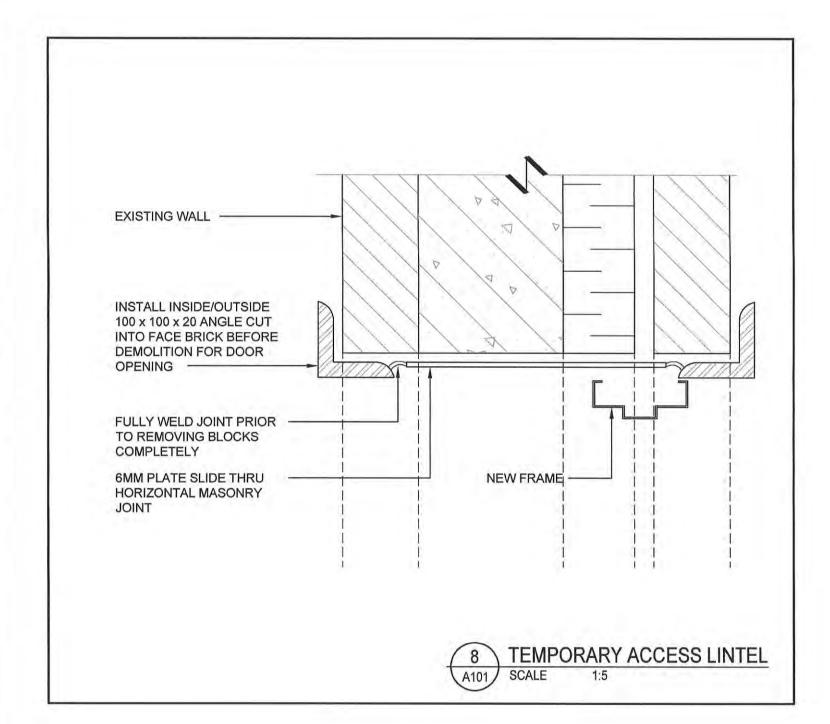



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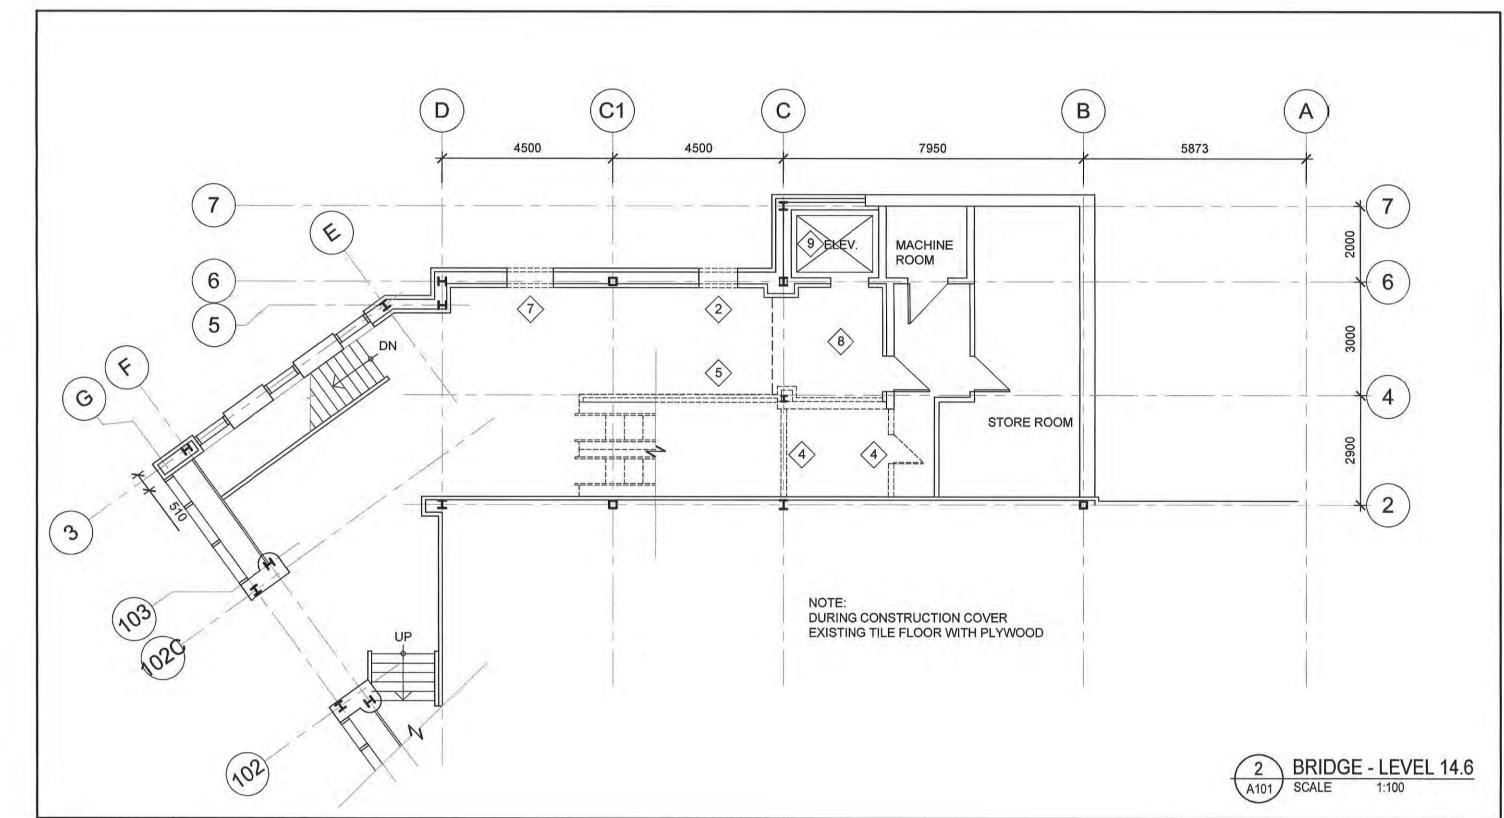
U/S OPENING


7 W1- WALL SECTION DETAIL
SCALE 1:10



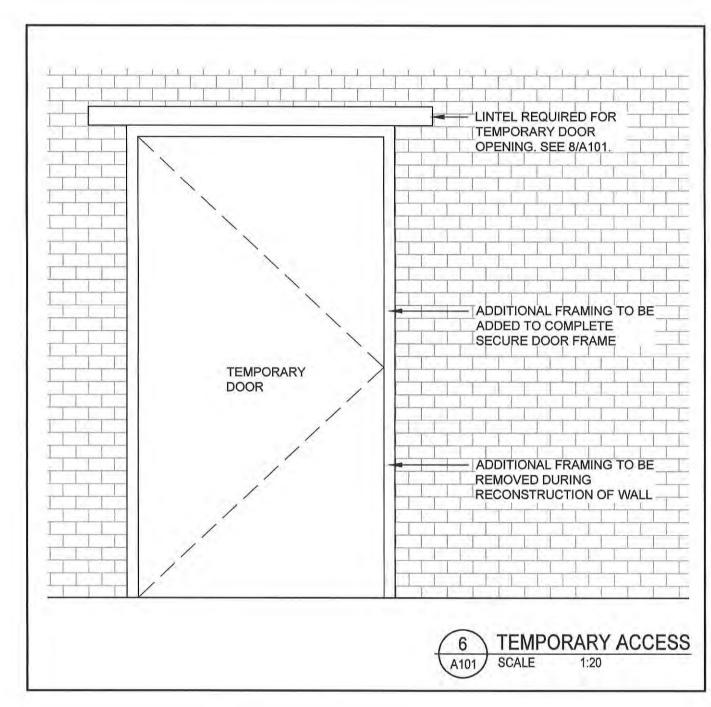

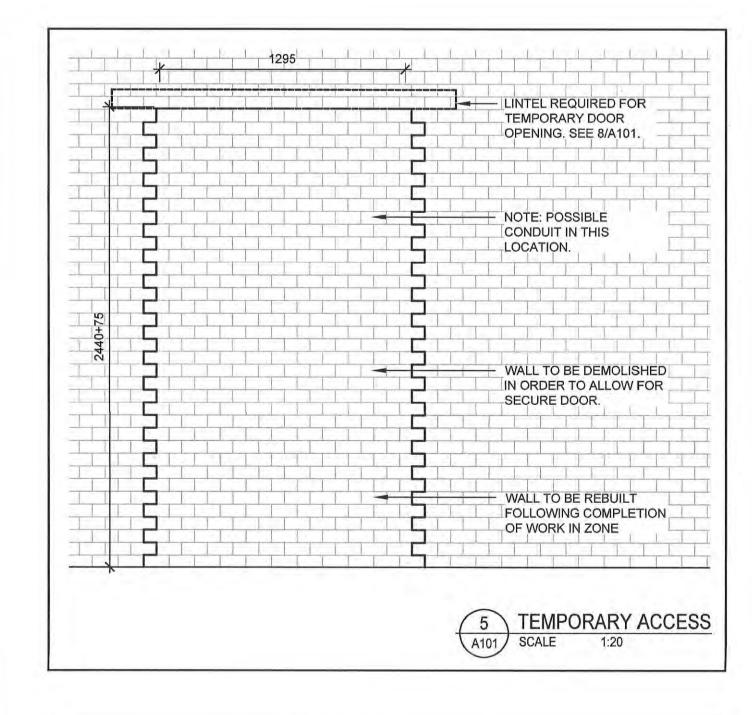

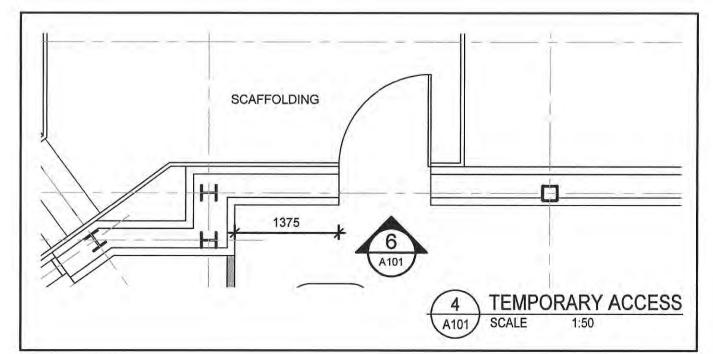


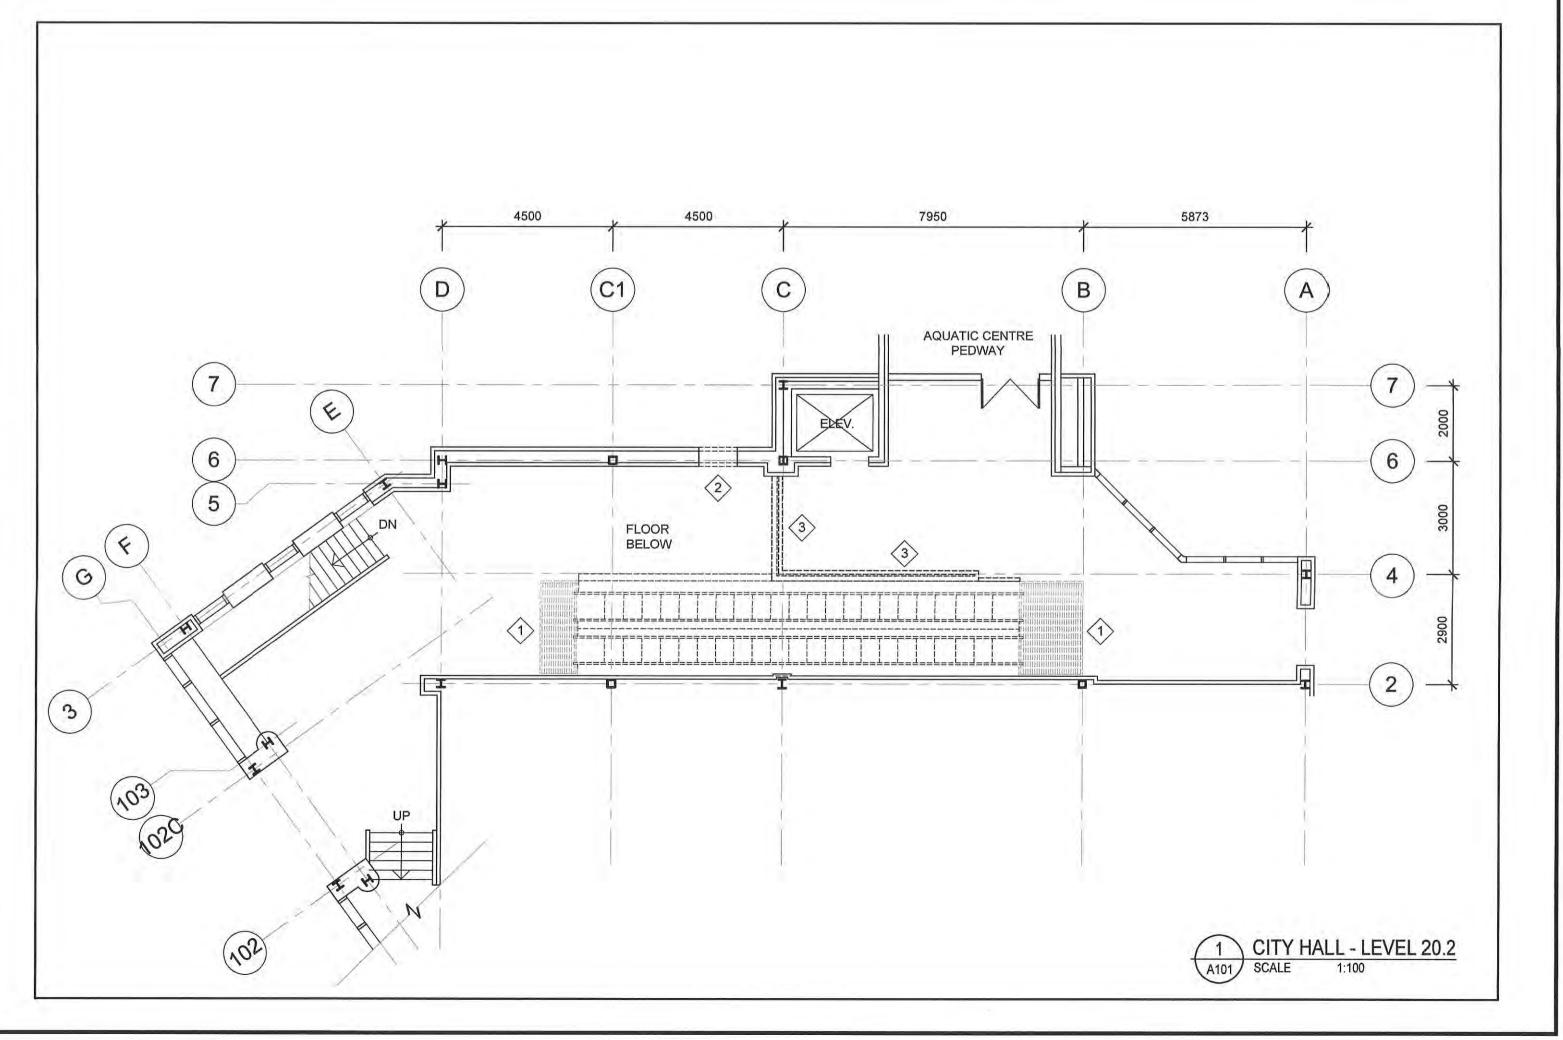





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1. BRICKS TAKEN FROM DEMOLISHED WALLS TO BE REUSED AND RECLAIMED AS INDICATED IN THE DRAWINGS.

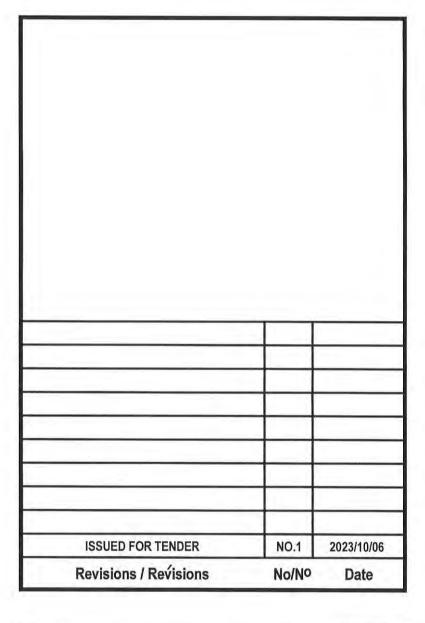Titre du projet ST. PATRICK STREET PEDWAY **RENOVATION AND ELEVATOR ADDITION** 

ST. PATRICK STREET SAINT JOHN, NEW BRUNSWICK

**DEMOLITION** 

**PLANS** 

AS NOTED Approuvé par i

Consultant reference number



Titre de la feuille

Nº de la feuille 19-719 A101

EXISTING WALL ABOVE -

DURING INFILL OF WALL

W1 EXTERIOR WALL INFILL

TO MATCH EXISTING. -TOOTH IN ALL JOINTS.

EXISTING WALL BELOW ----


EXISTING.


-REBUILD WALL WITH SALVAGED BRICK. -PROVIDE AIR SPACE TO MATCH


-PATCH INSULATION TO MATCH EXISTING. -REBUILD CONCRETE BLOCK WALL TO


MATCH EXISTING. -REBUILD INTERIOR BRICK VENEER WALL


REMOVE TEMPORARY OPENING LINTEL

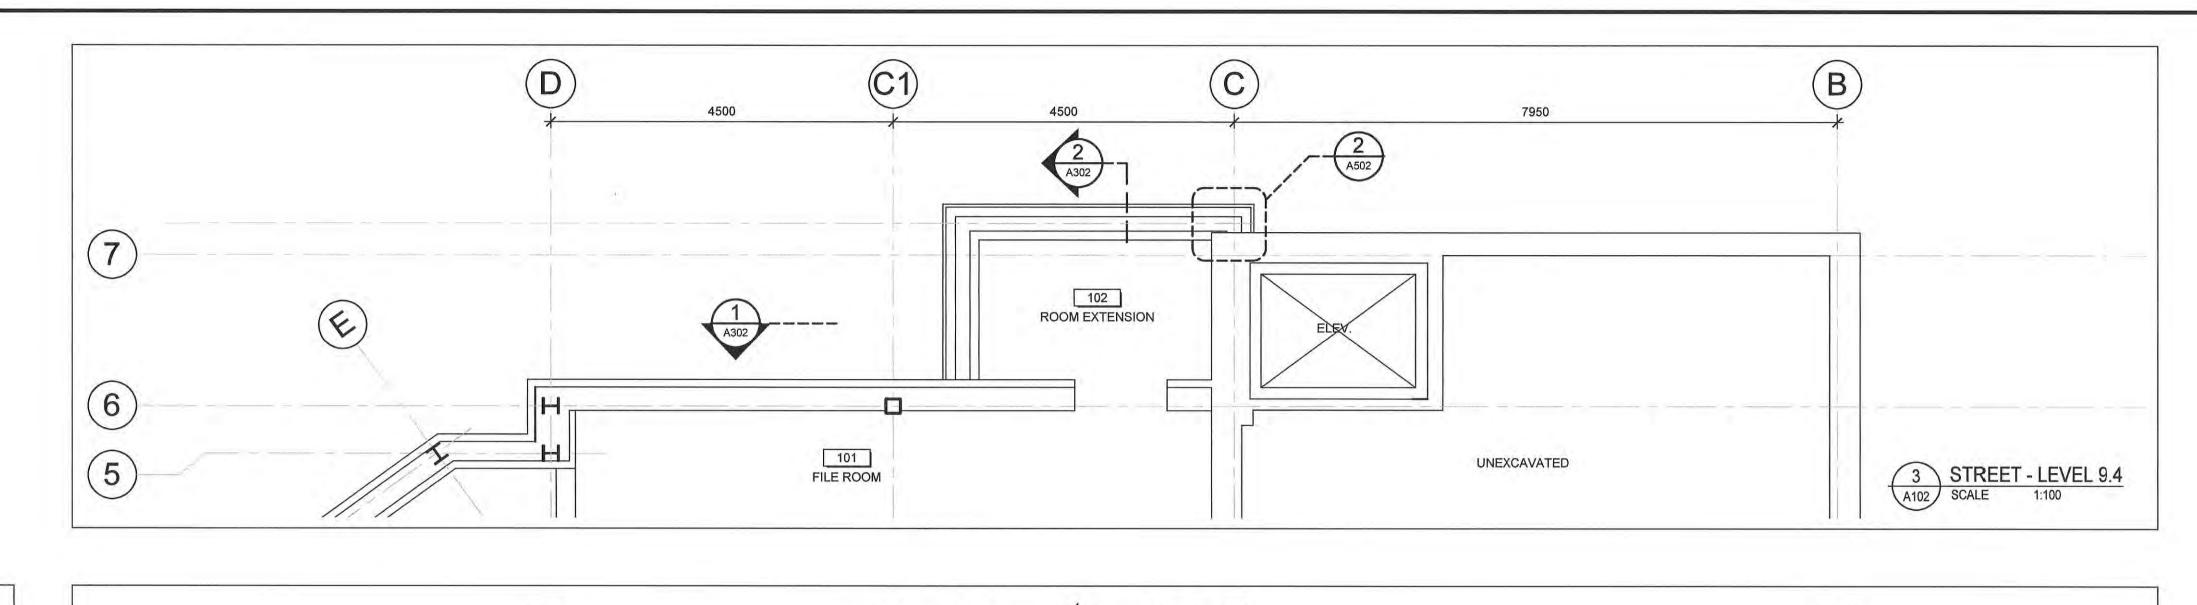

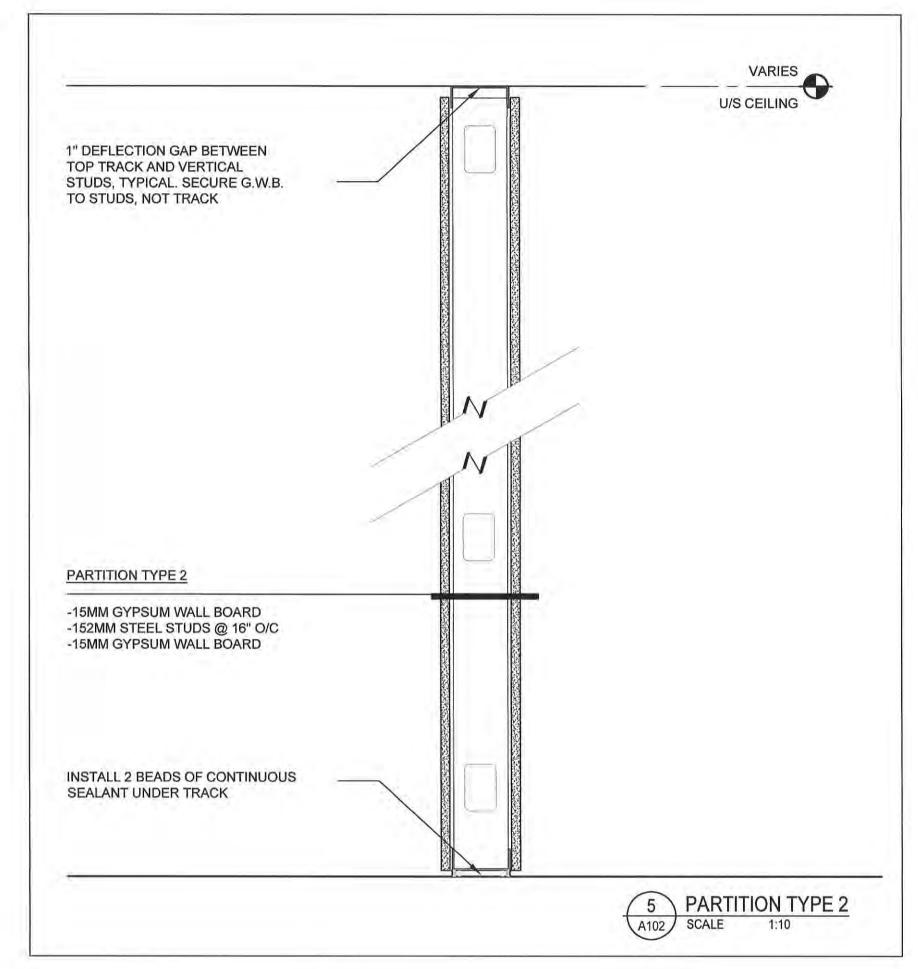


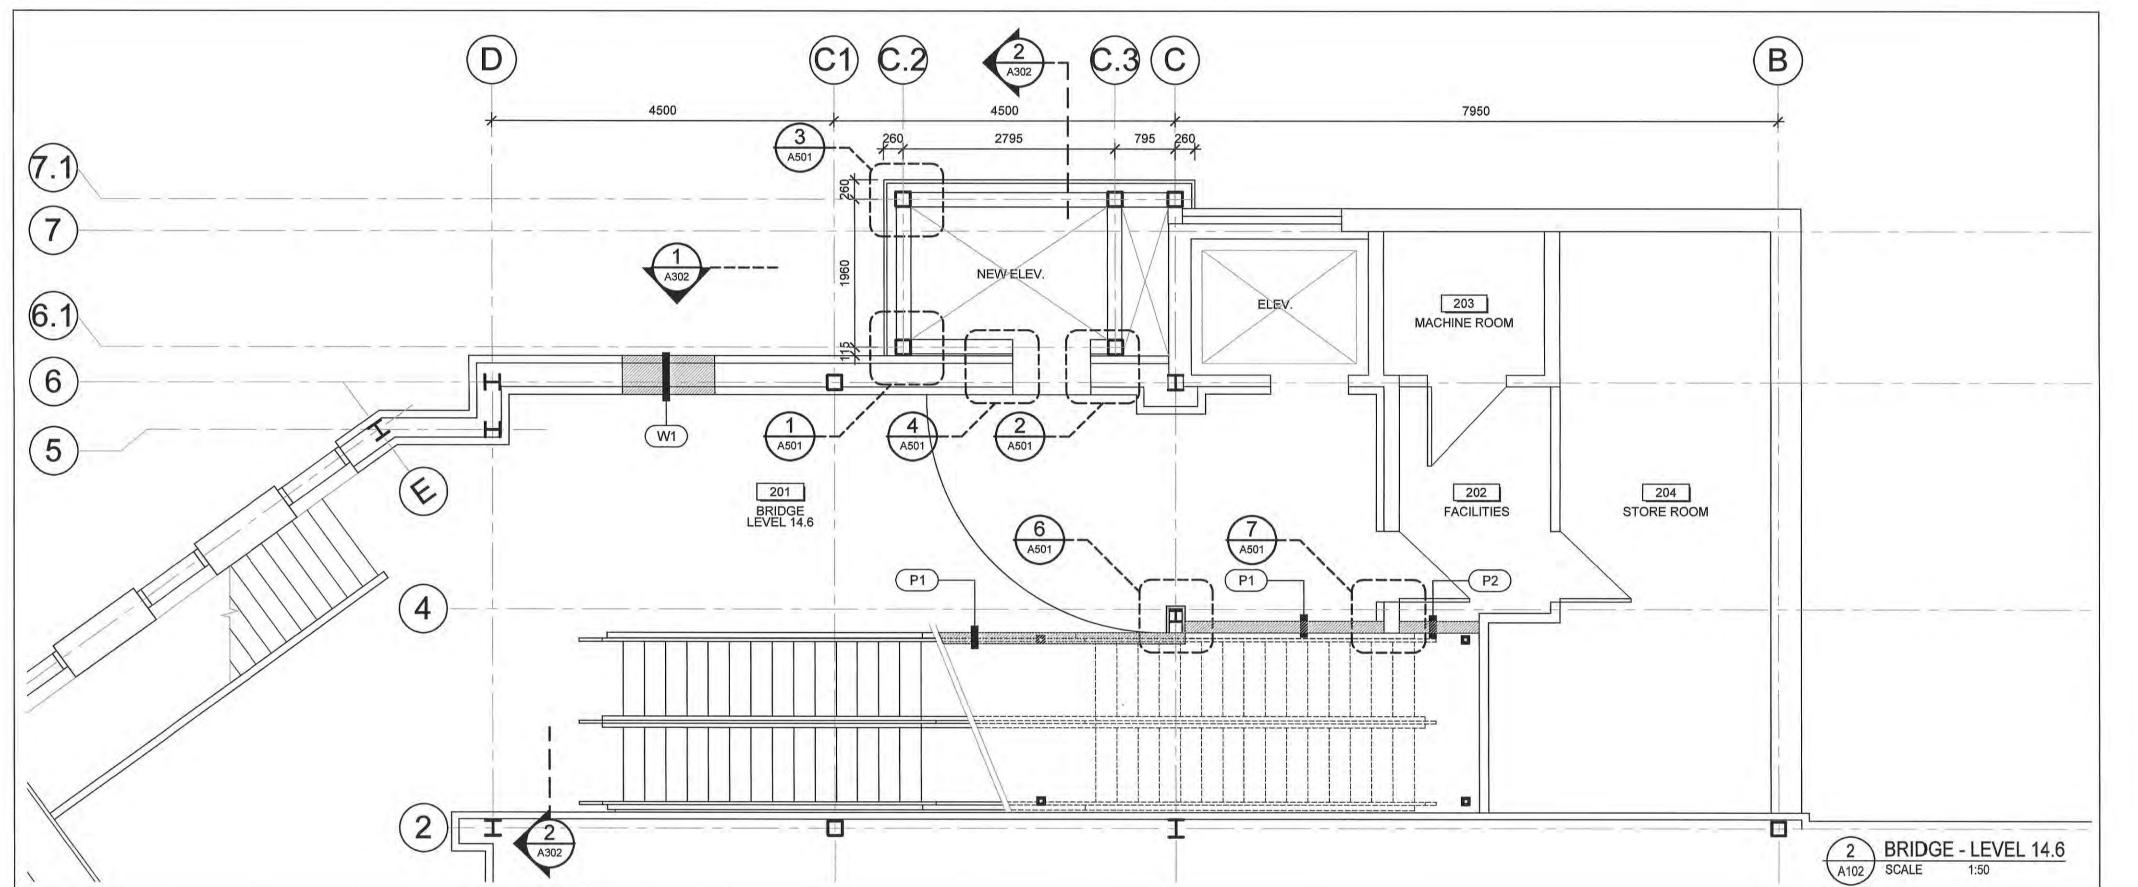


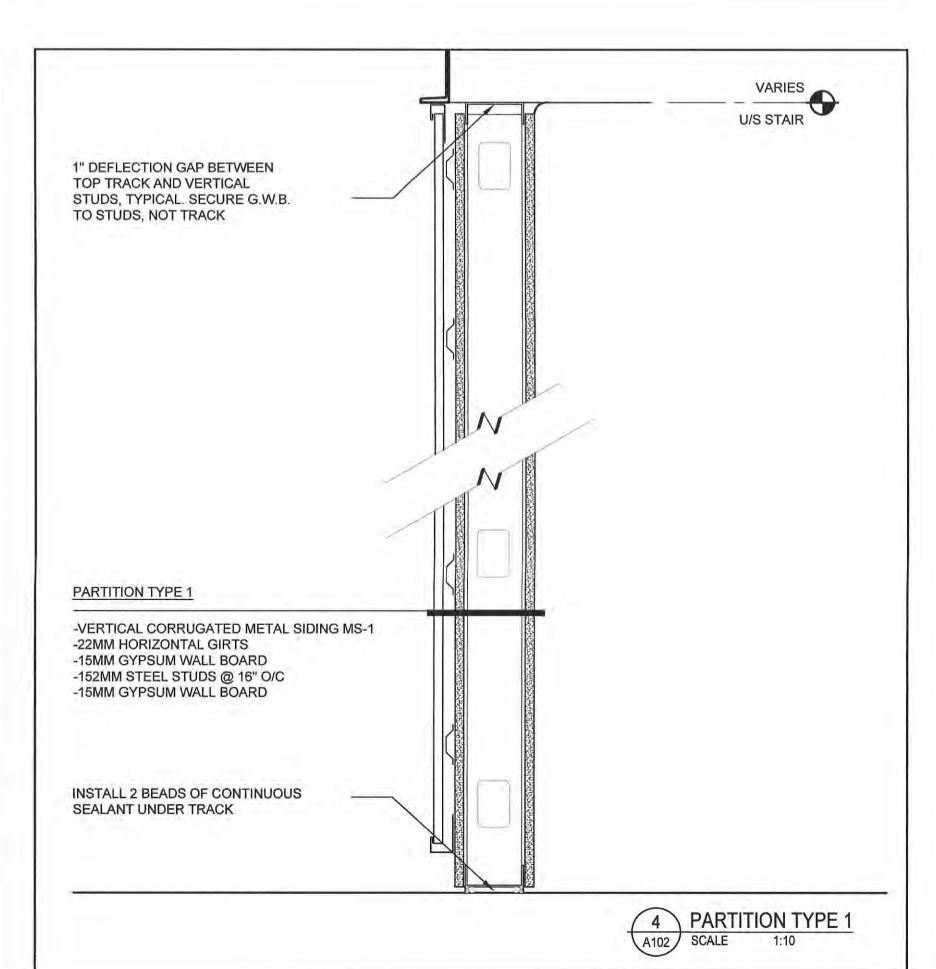


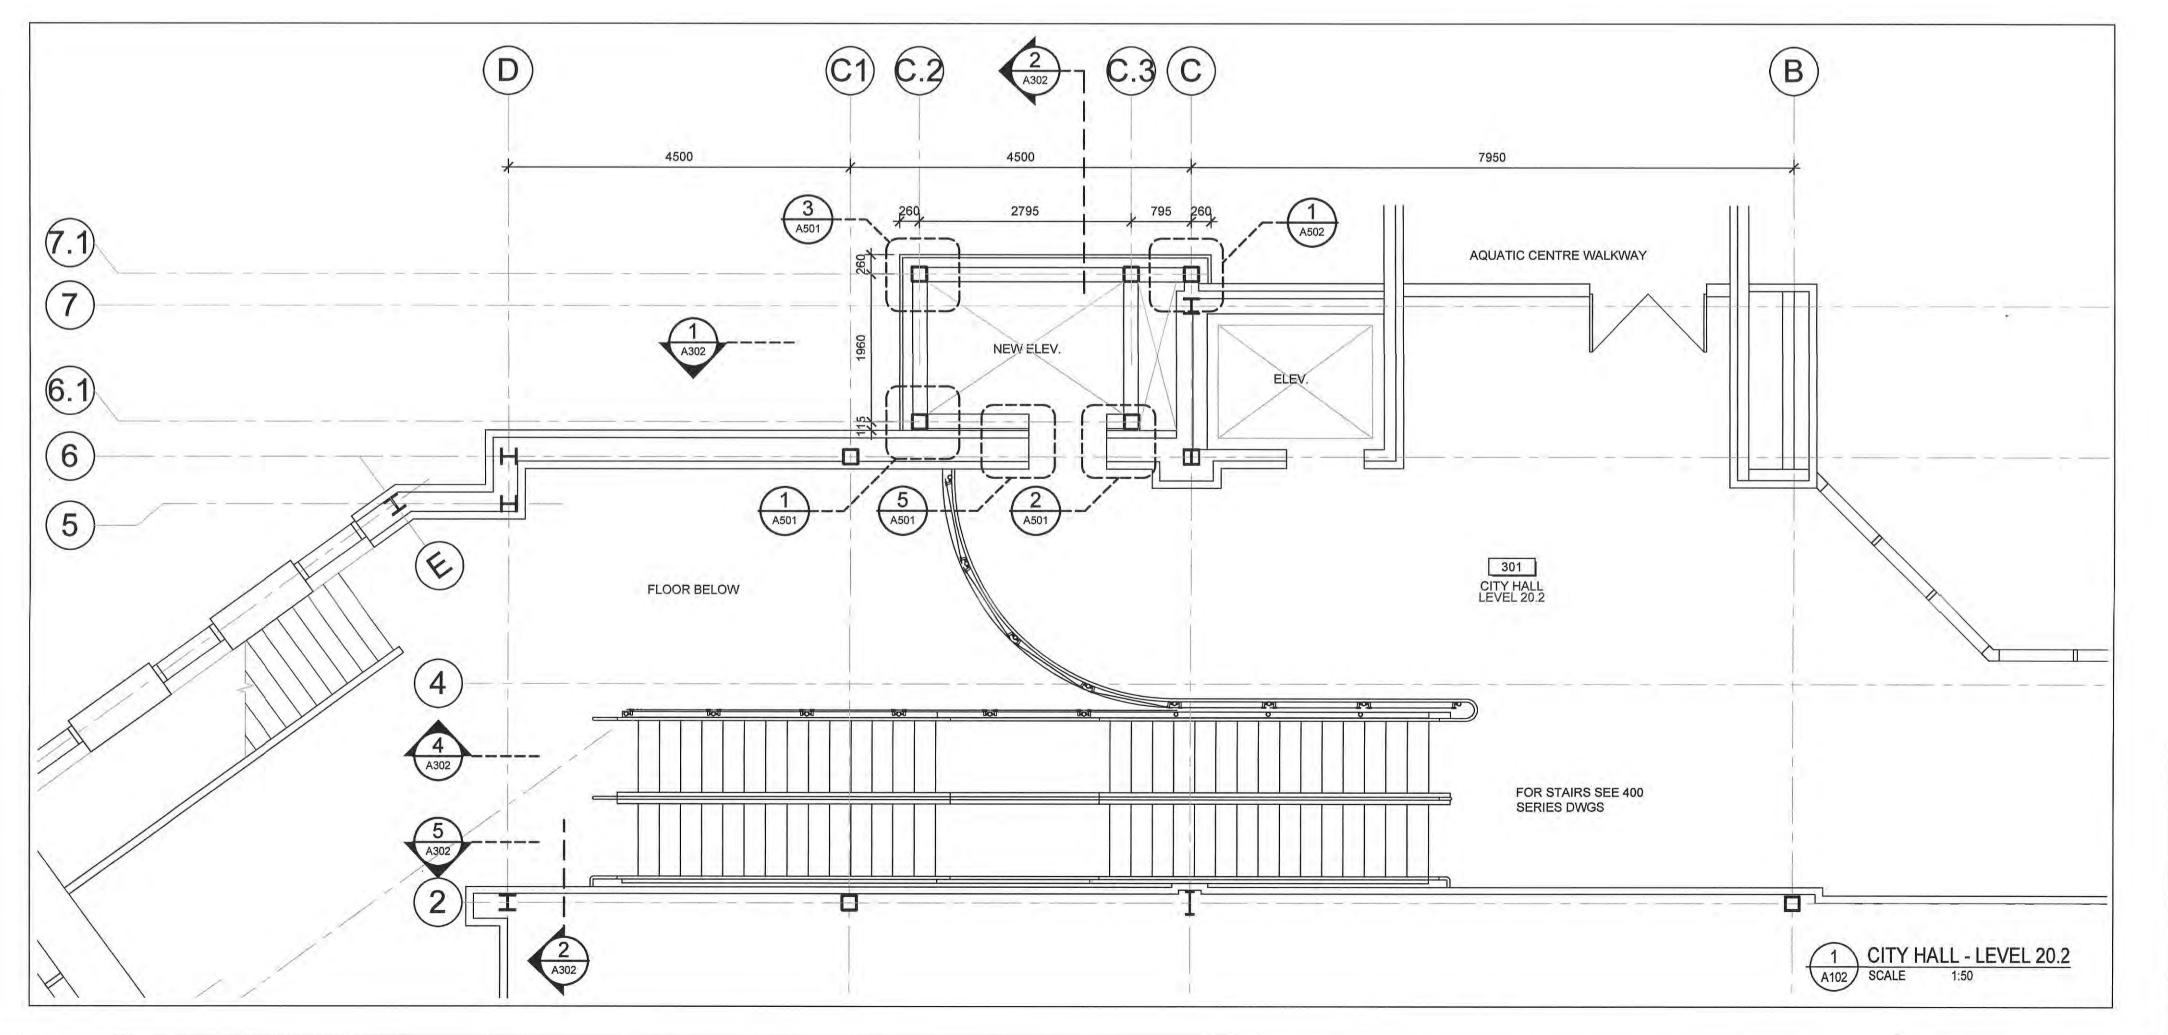



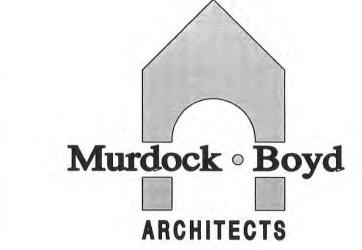

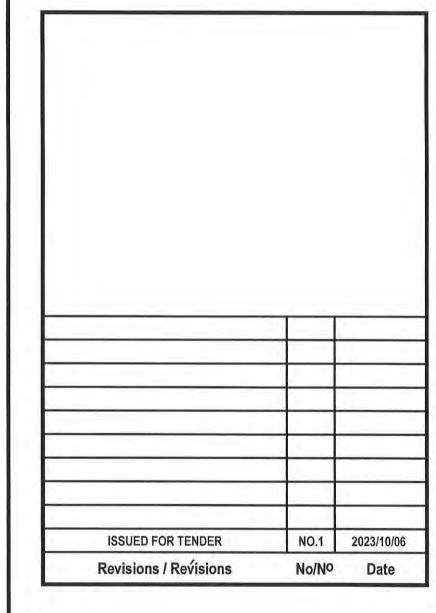

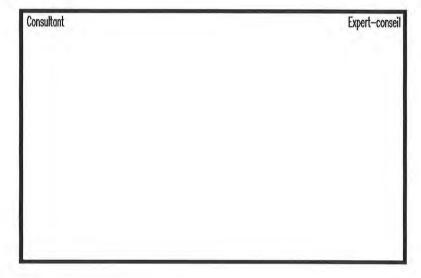

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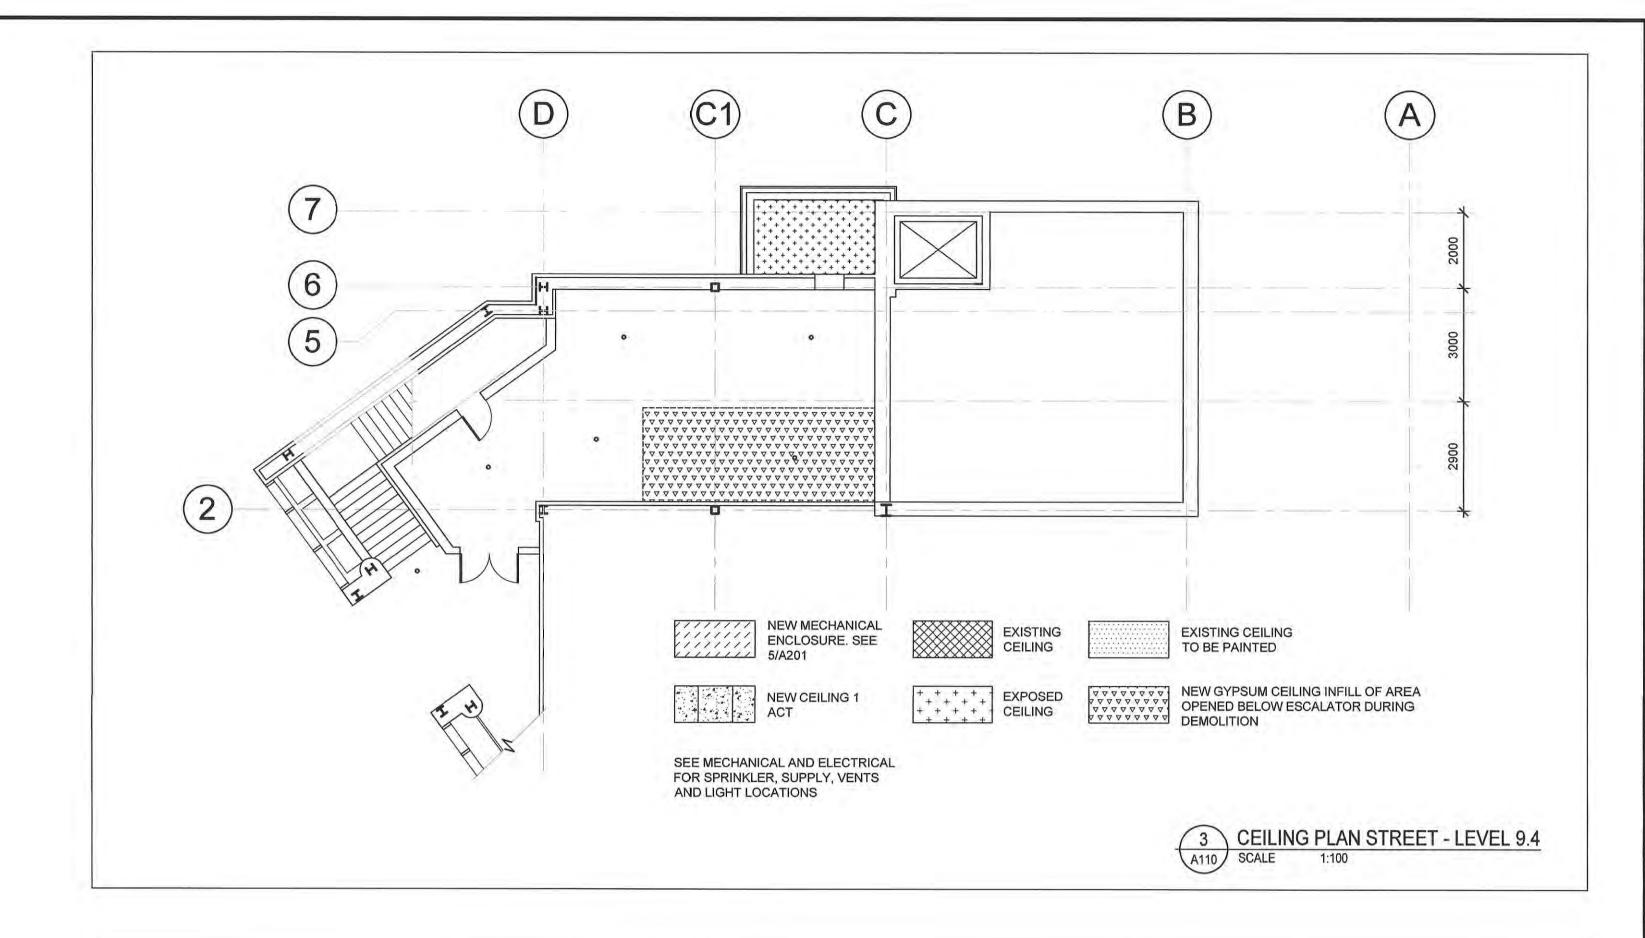
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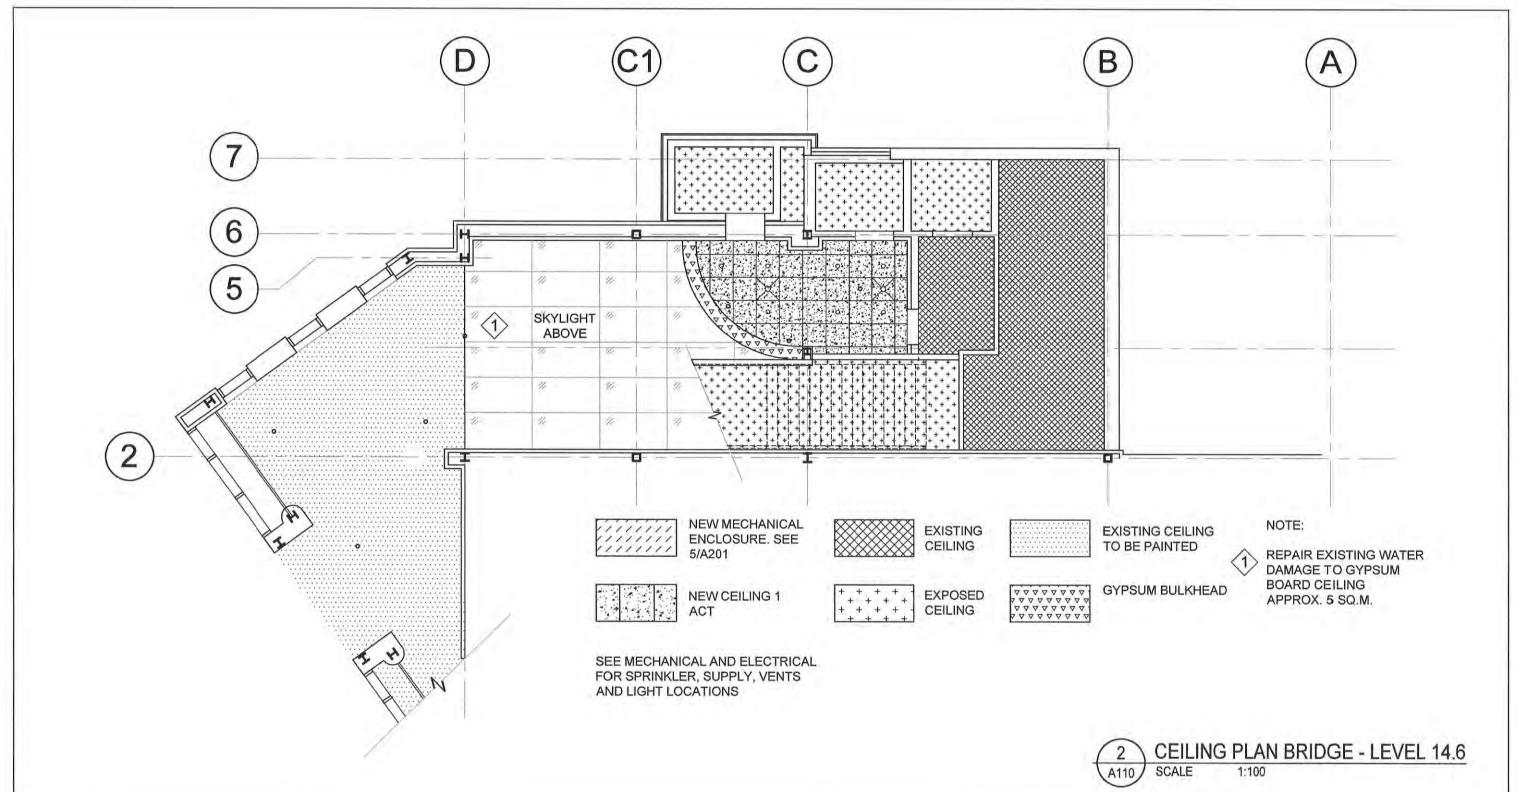
FLOOR PLANS AND PARTITIONS


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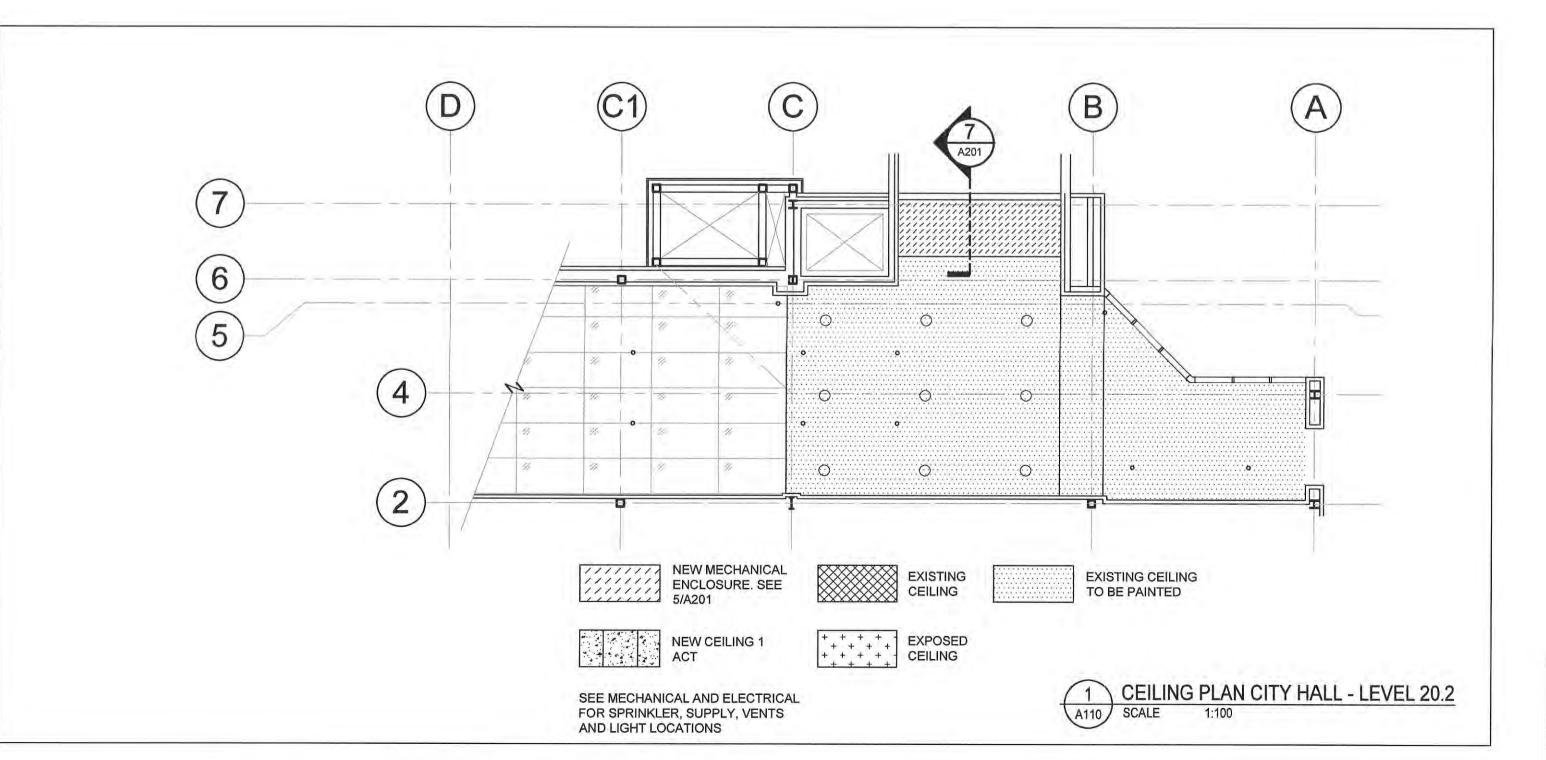
Date 2023.10.06 Date Stamp Scale AS NOTED Échelle Drawn by EAS Dessiné par Approved by MRB Approuvé par Consultant reférence de référence de l'expert-conseil

19-719 Sheet No. No de la feuille A102










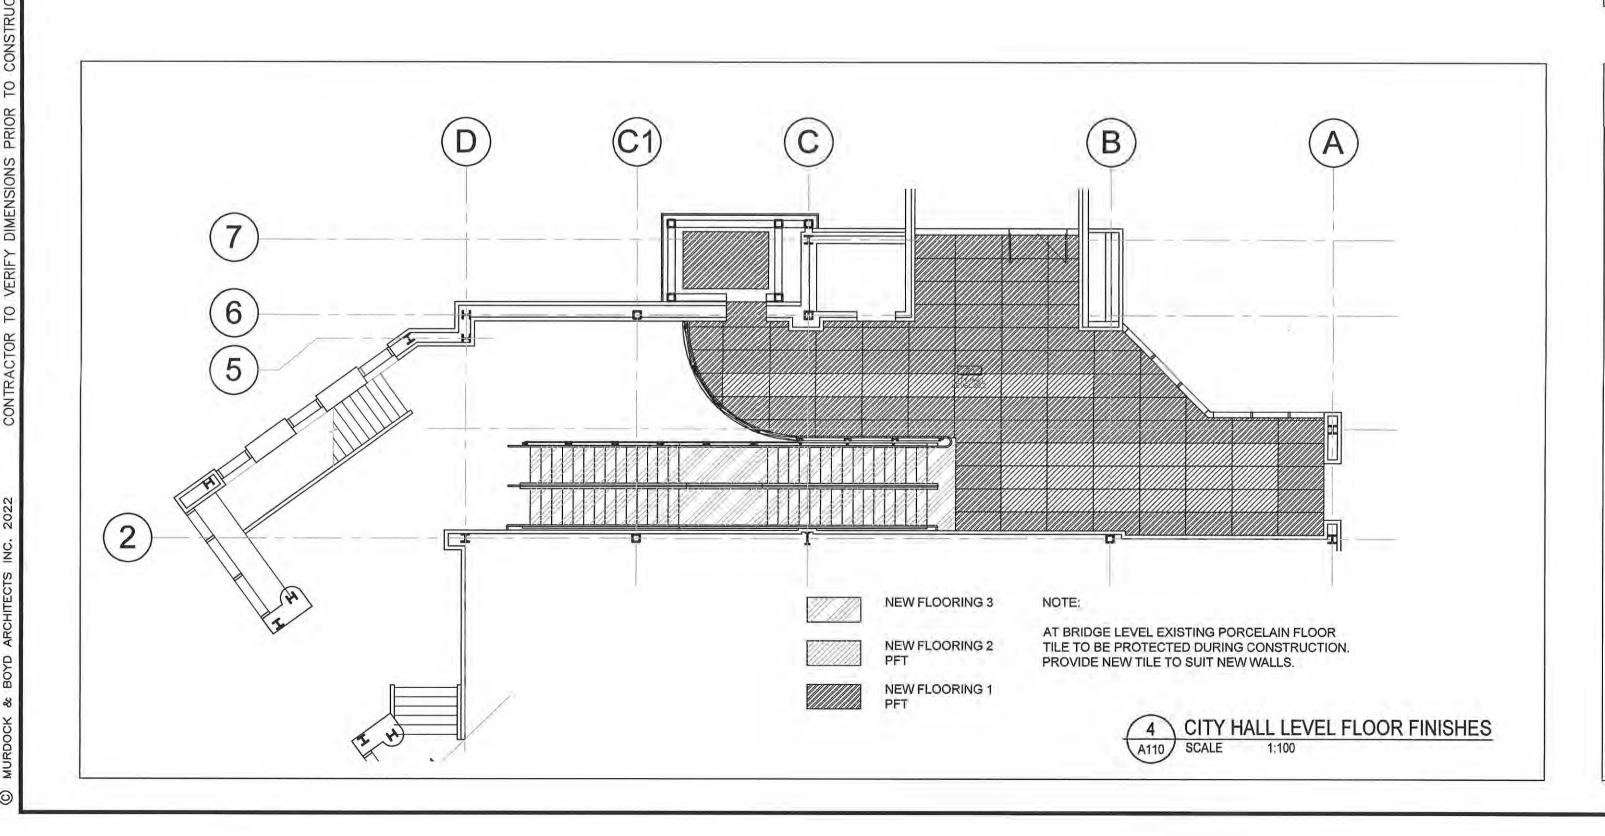



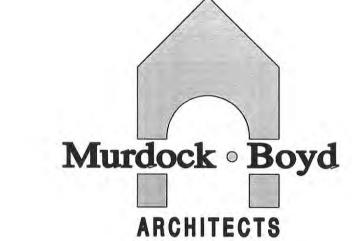

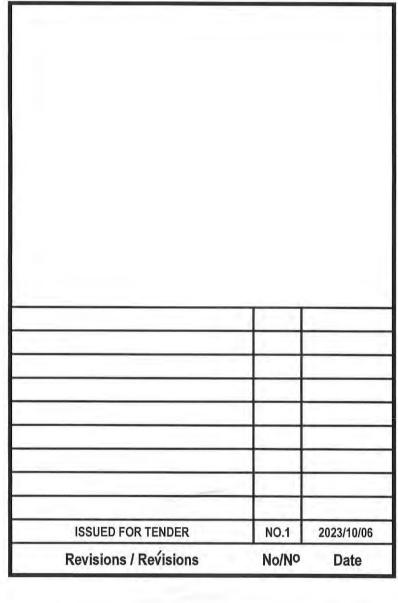

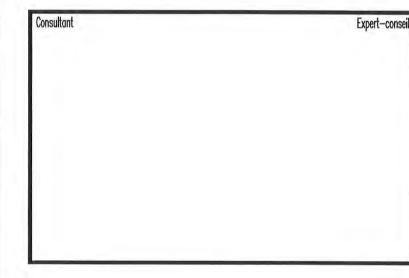

ST. PATRICK STREET PEDWAY RENOVATION AND ELEVATOR ADDITION

ST. PATRICK STREET
SAINT JOHN, NEW BRUNSWICK

SAINT JOHN, NEW BRUNSW

CEILING PLANS & FLOOR FINISH PLANS

Date 2023.10.06

Scale Echelle AS NOTED

Drawn by Dessiné par EAS

Approved by Approuvé par MRB

Consultant Numéro de reference référence de number l'expert-conseil




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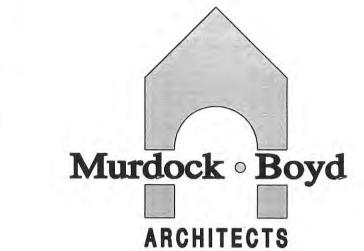
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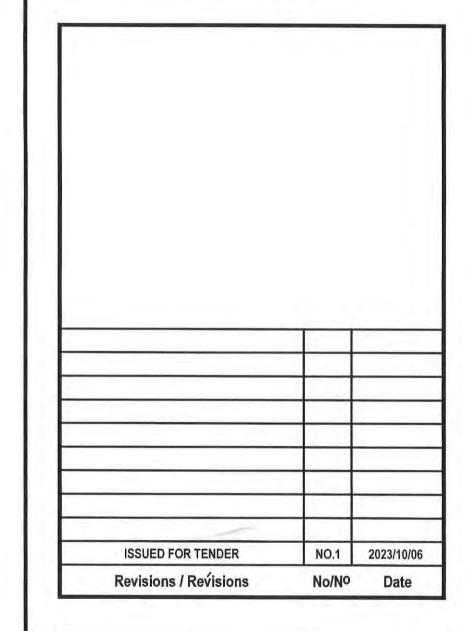
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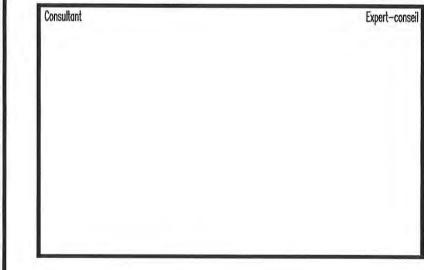
19-719 Sheet No. No de A110







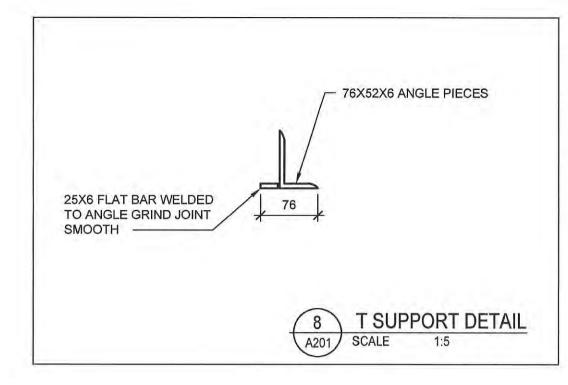





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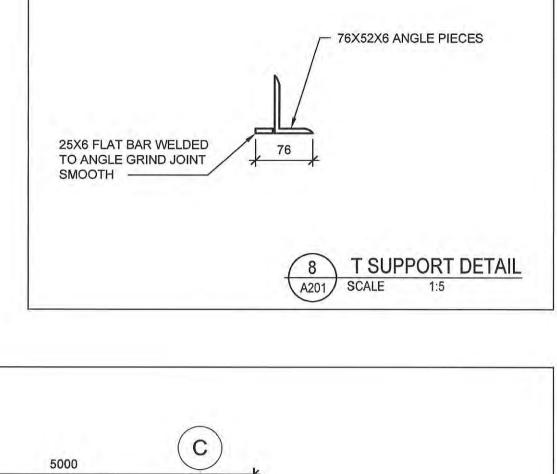
**EXTERIOR ELEVATIONS AND ROOF PLAN** 


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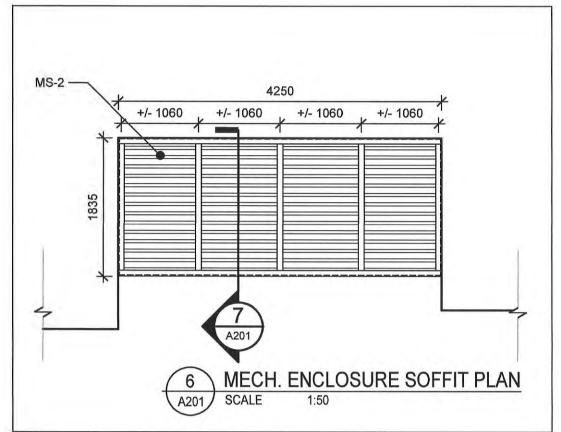
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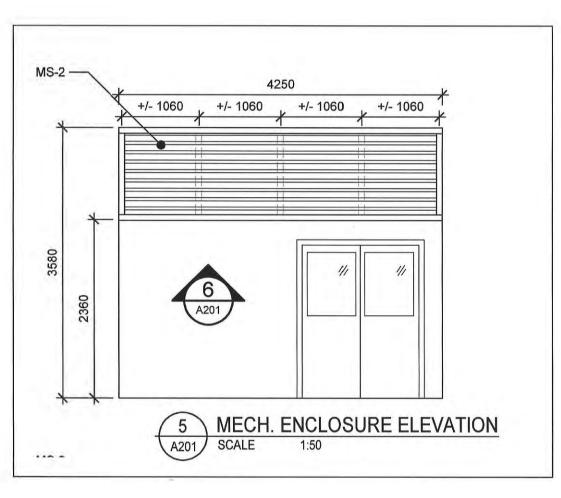
Malcolm R. Boyd MURDOCK & BOYD ARCHITECTS INC. 2023.10.18


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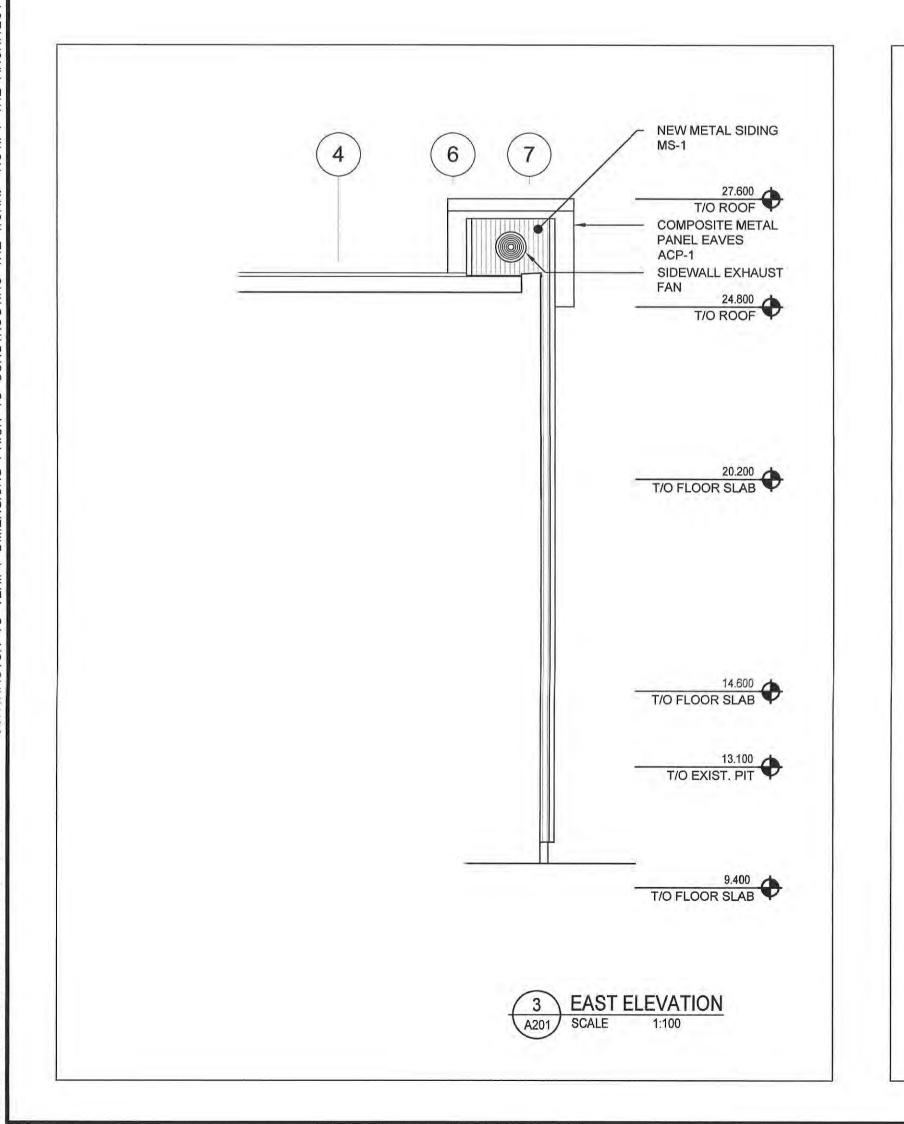











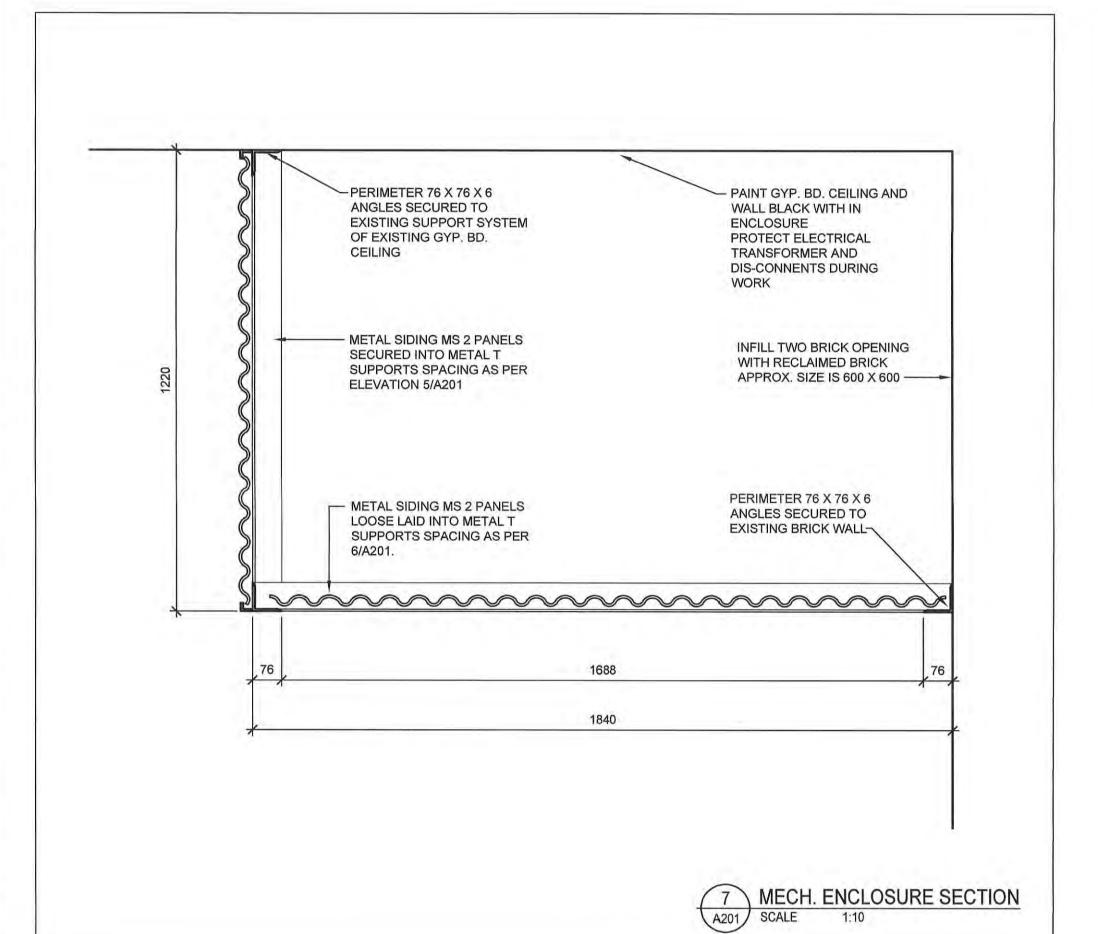


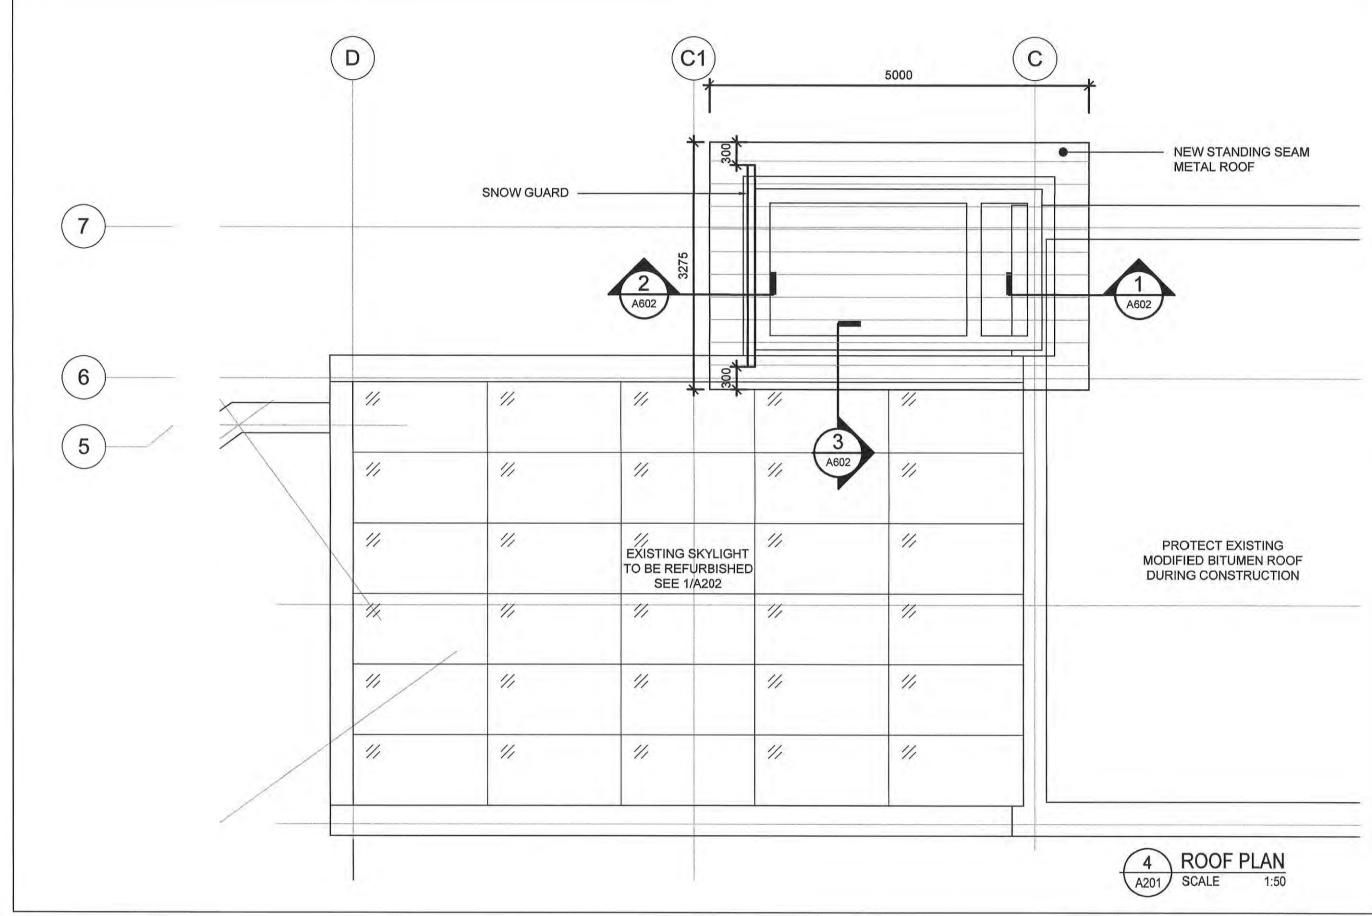


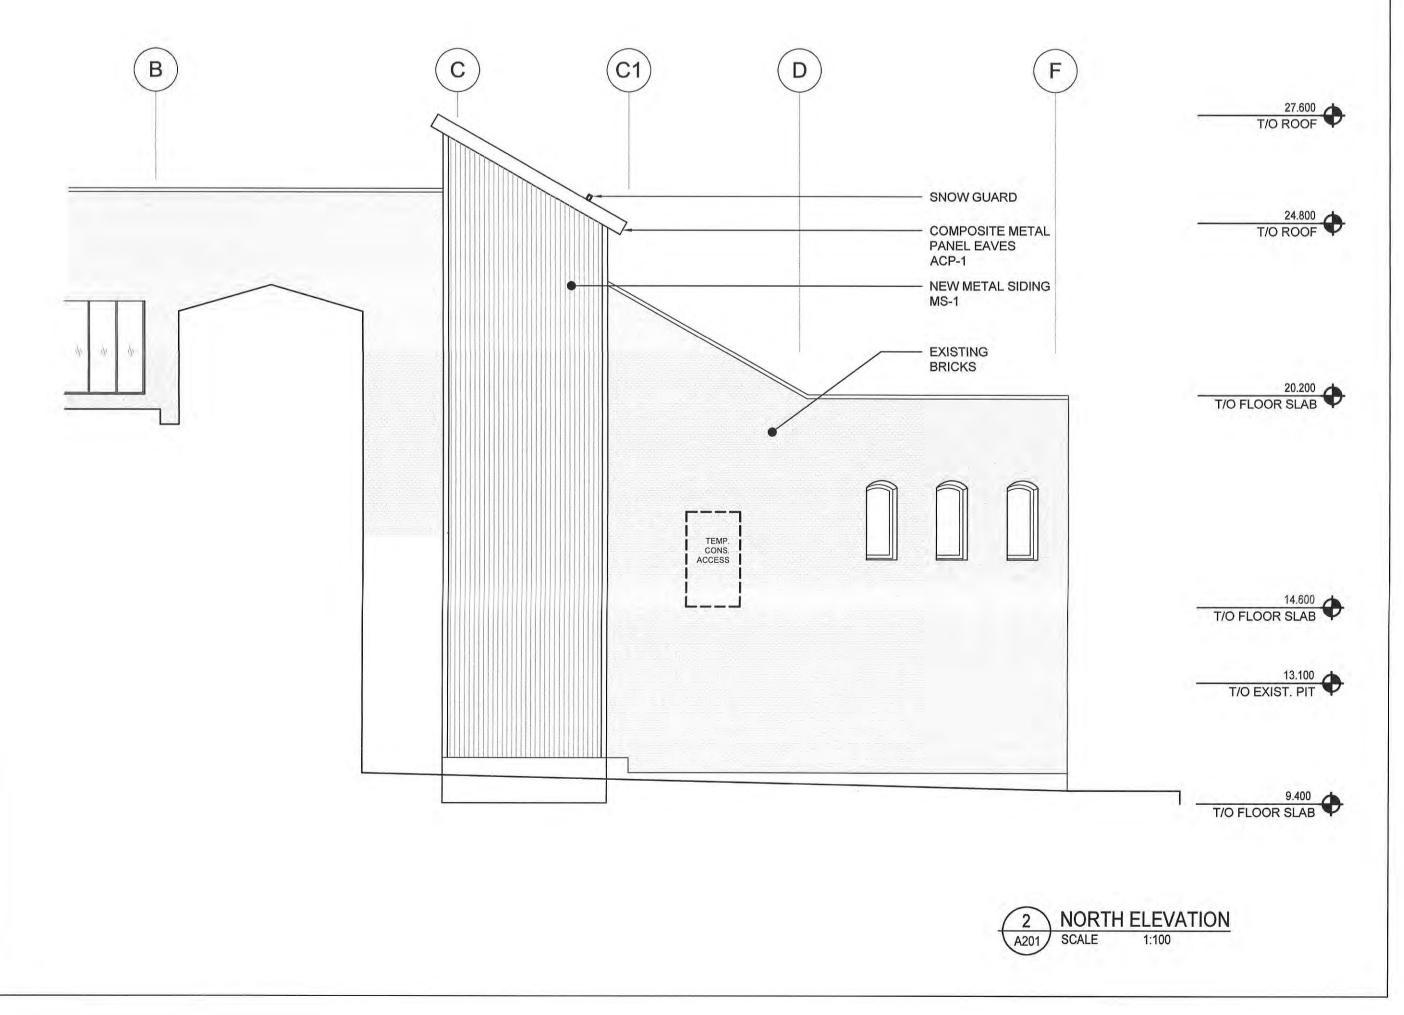


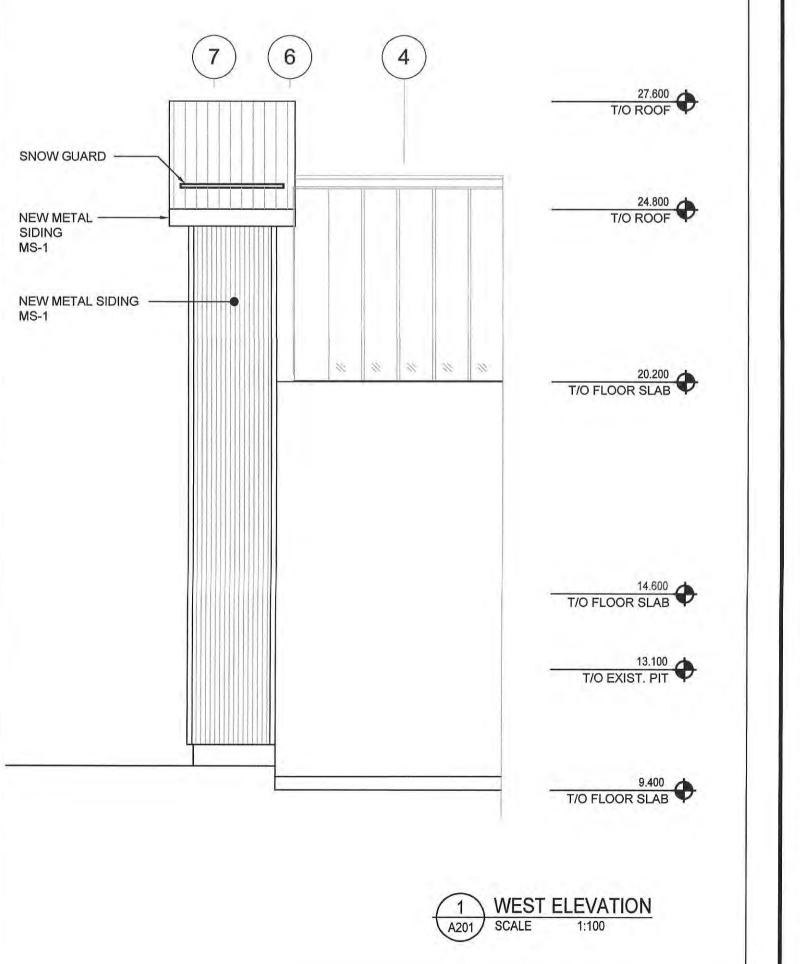


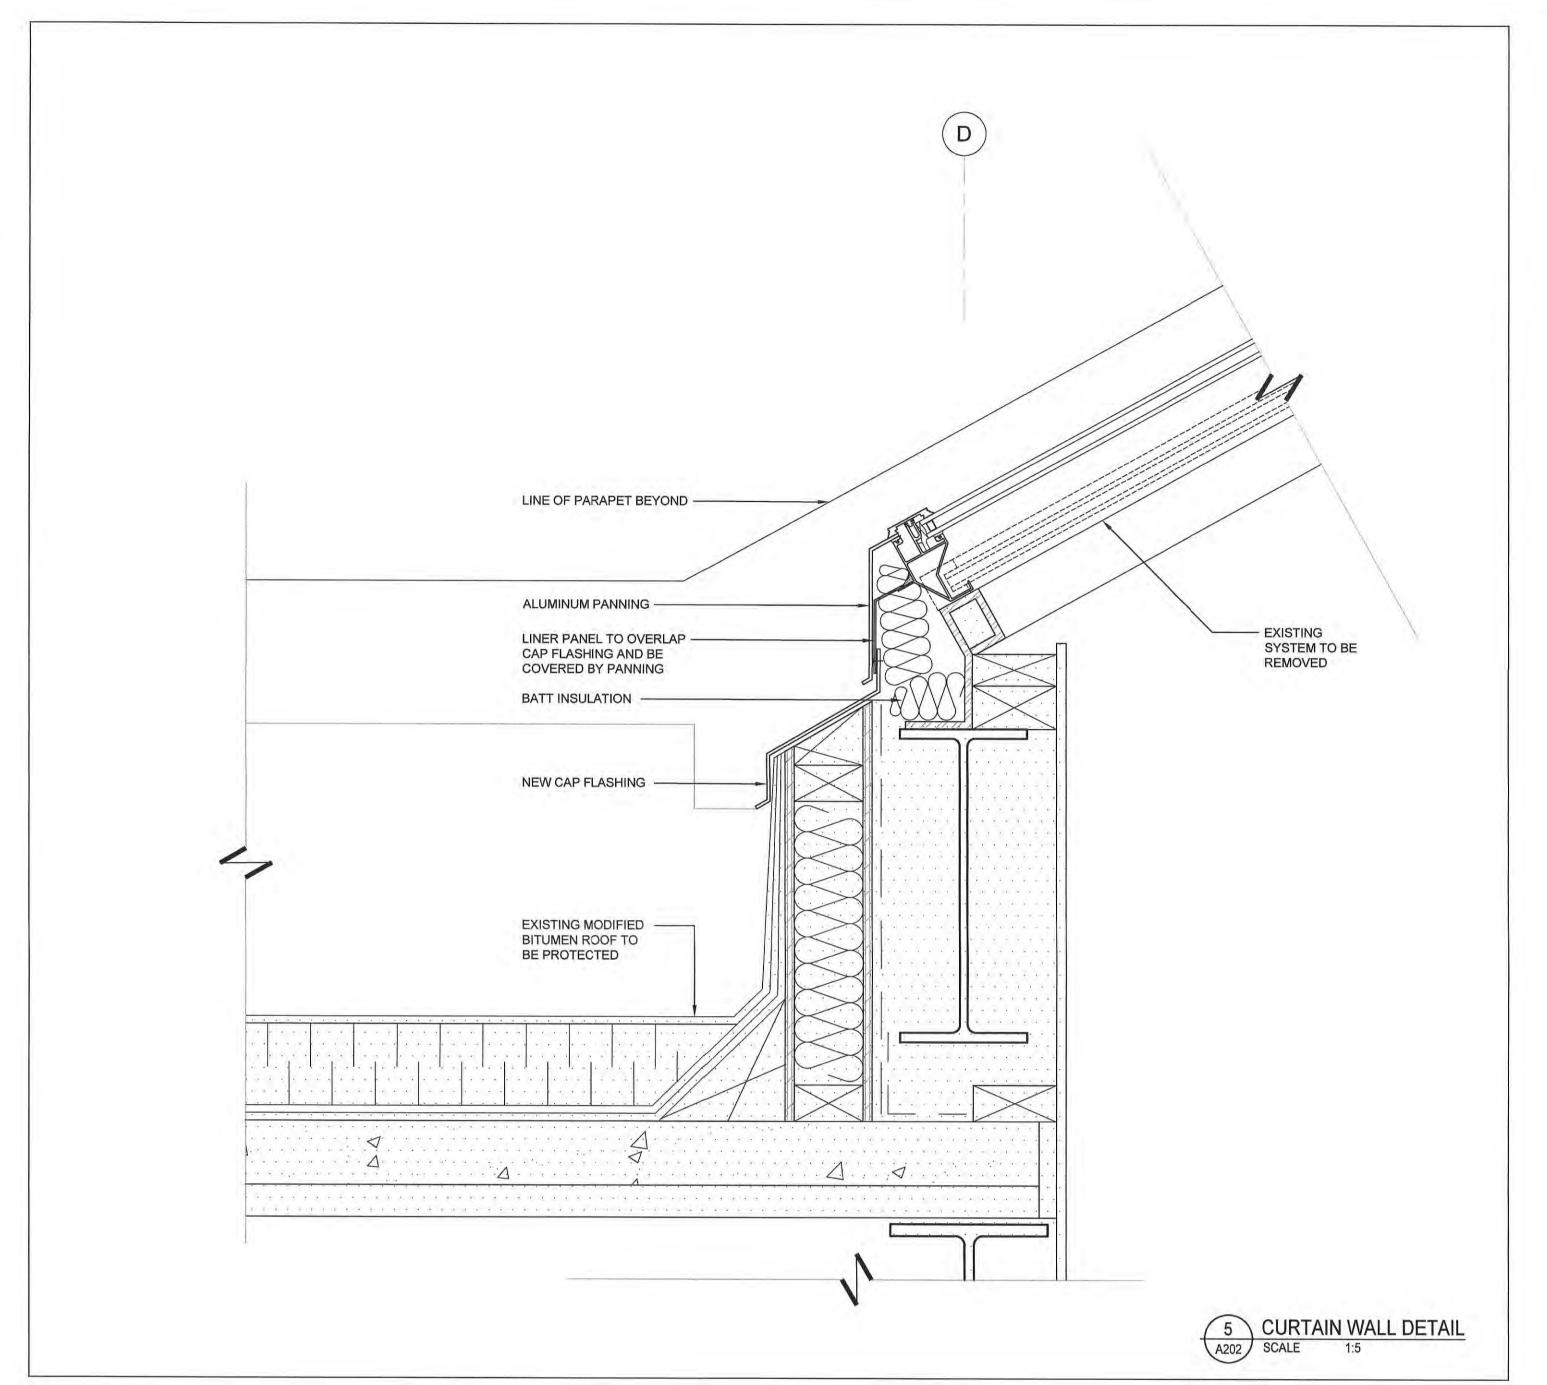

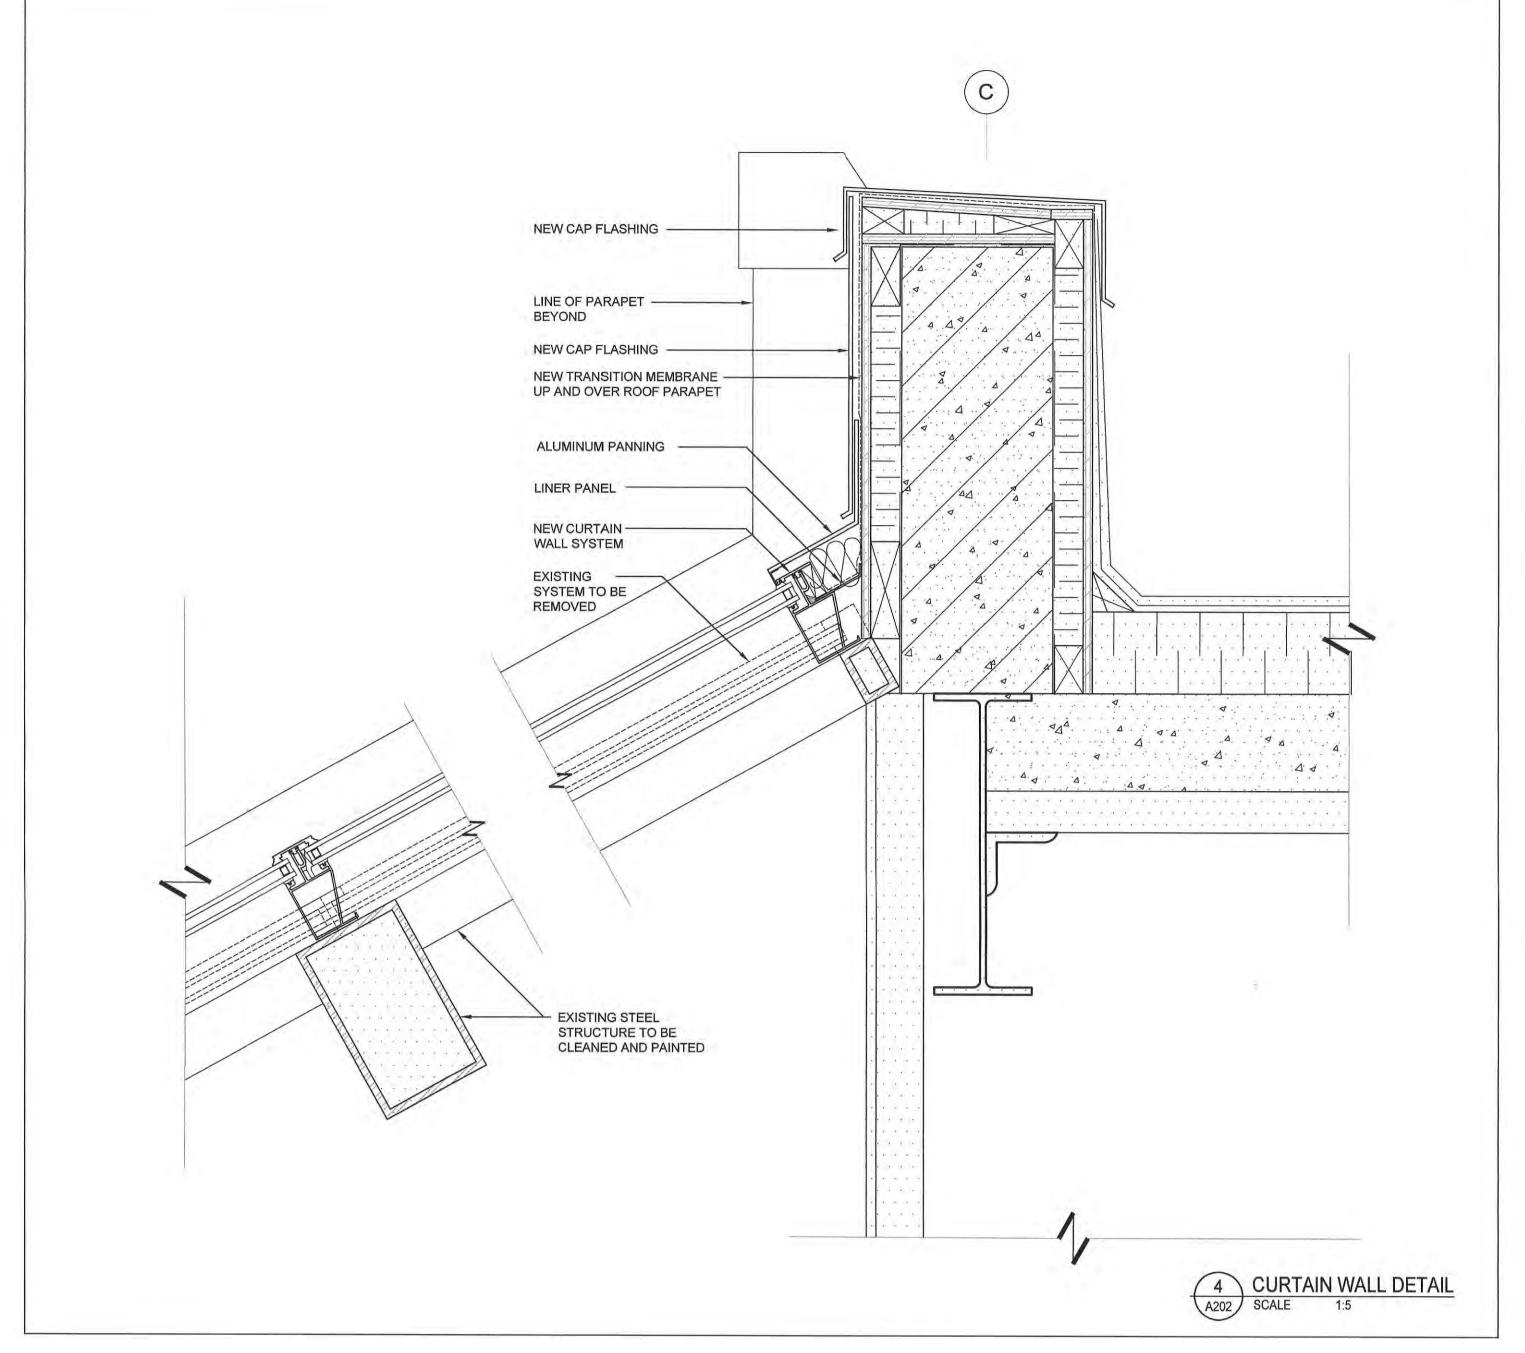

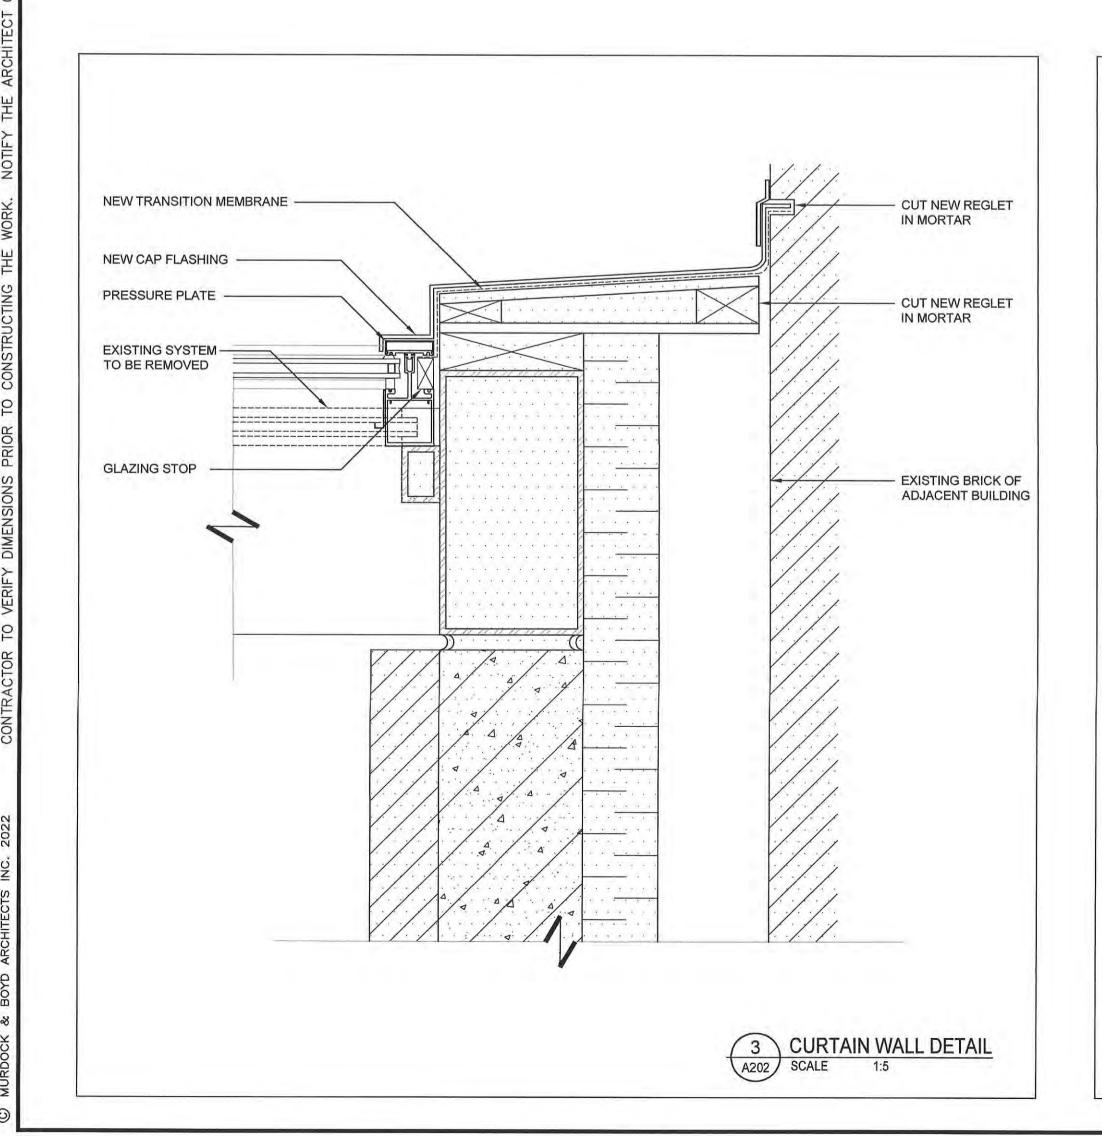


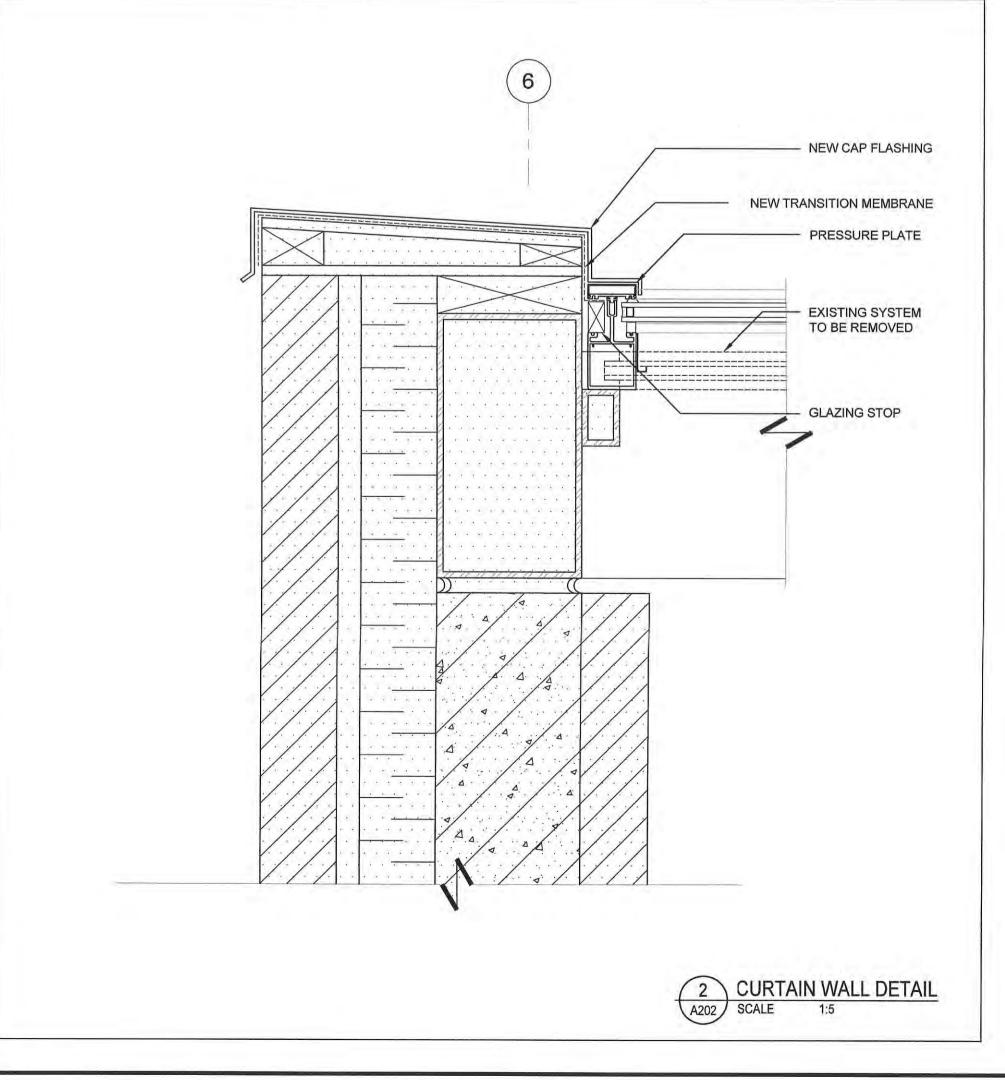


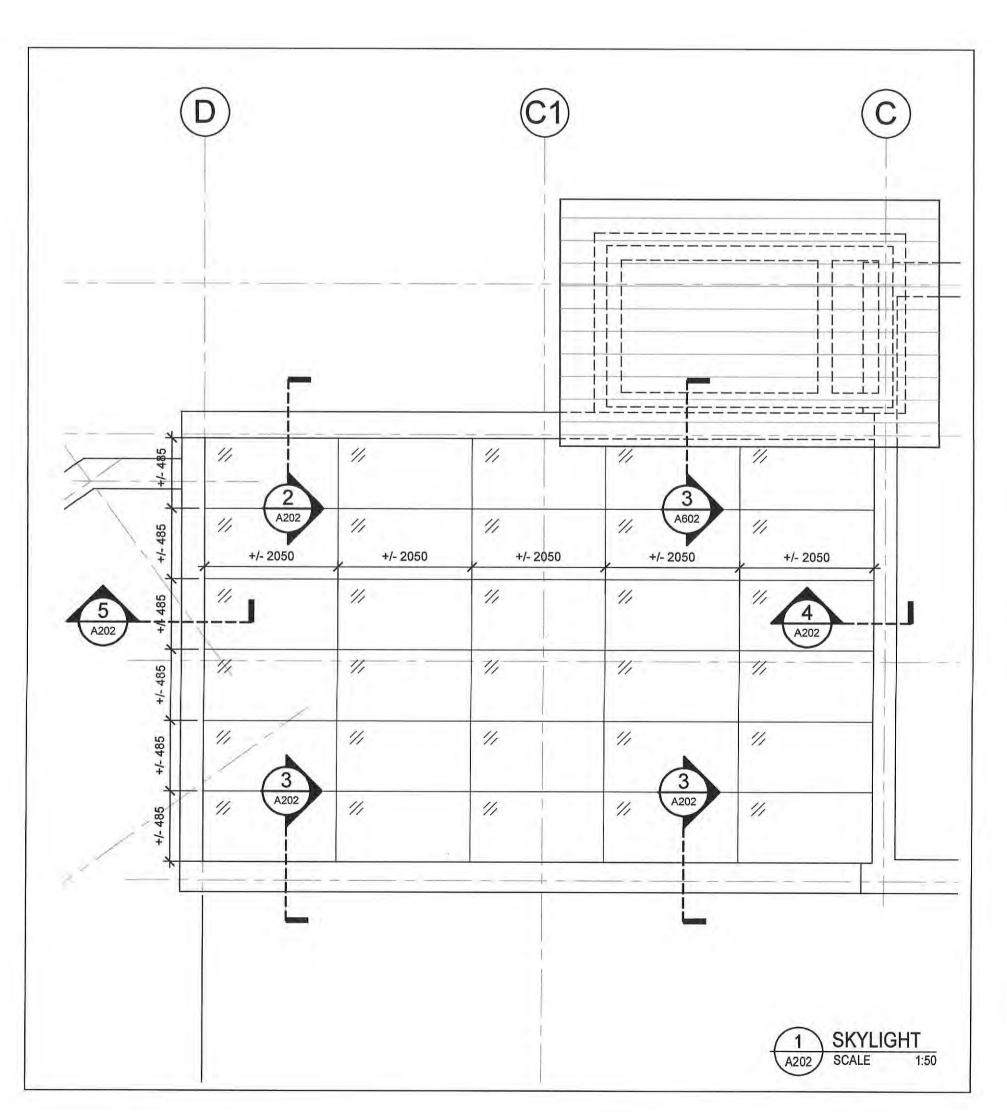





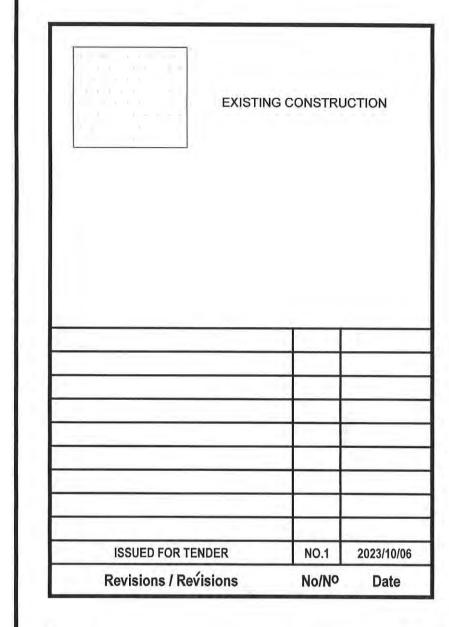

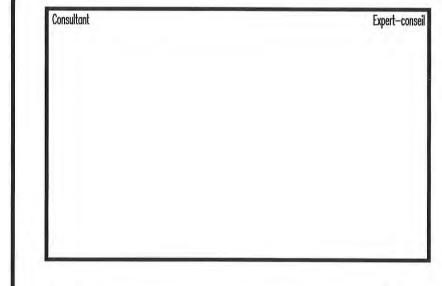

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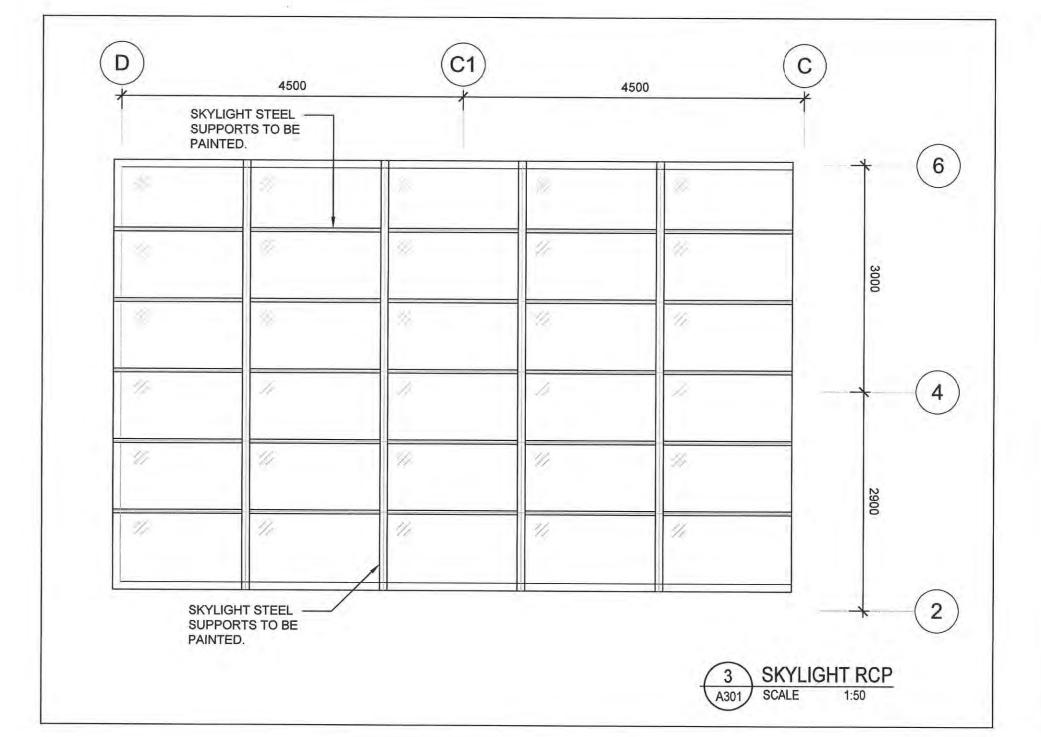
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ARCHITECTS INC.
ASSOCIATION of NEW AND ASSOCIATION OF NEW AN 2023. 10-18

Nº du projet Sheet No. A202


19-719




20.200 T/O FLOOR SLAB

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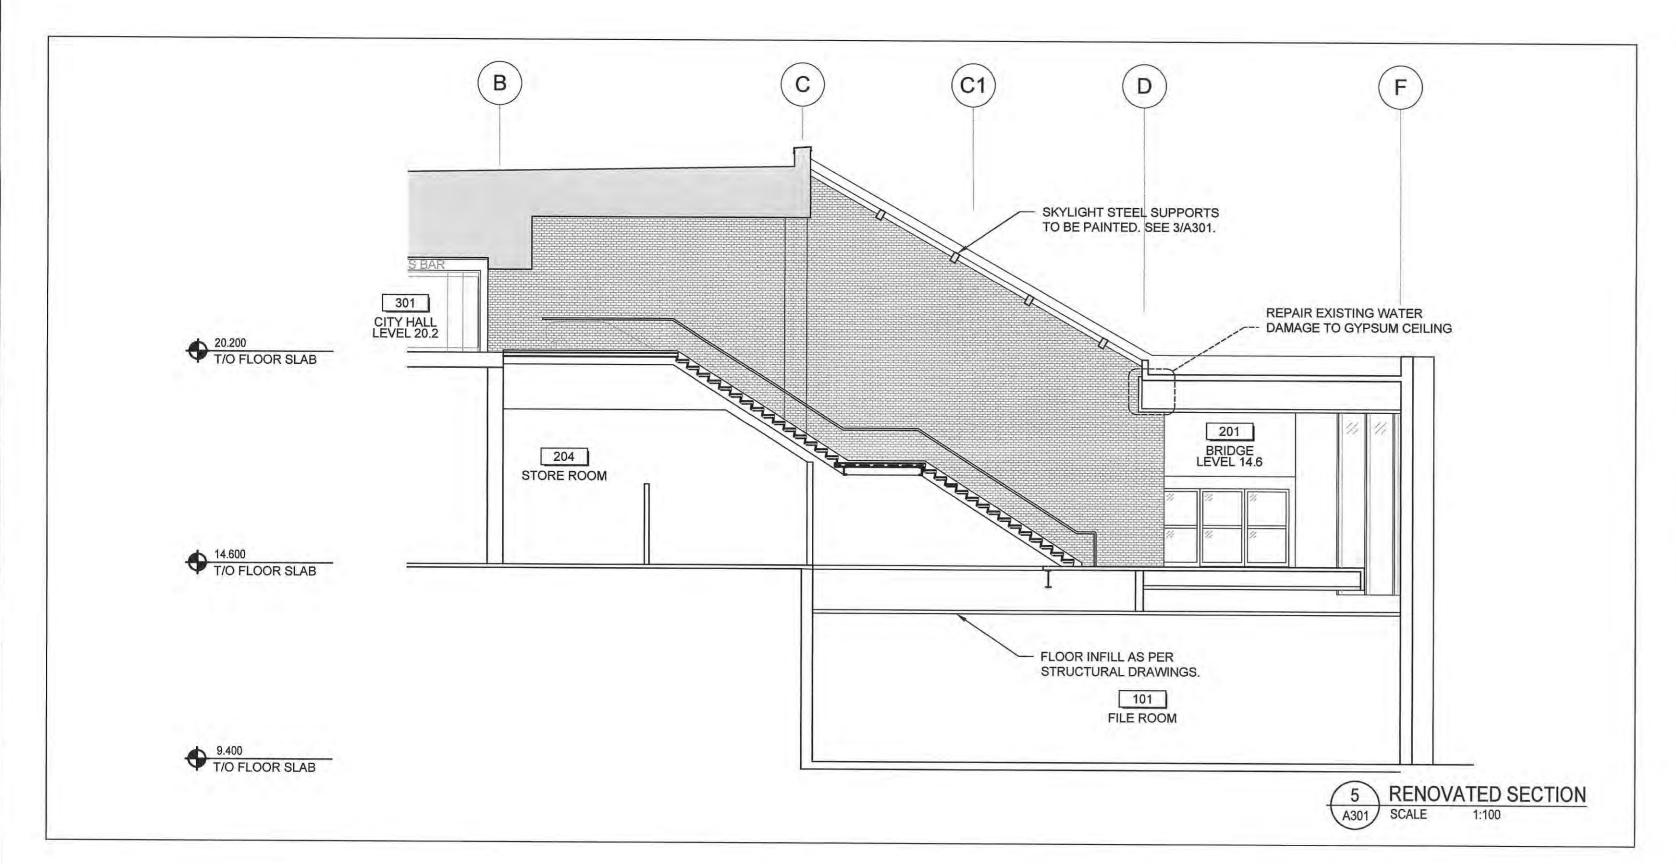
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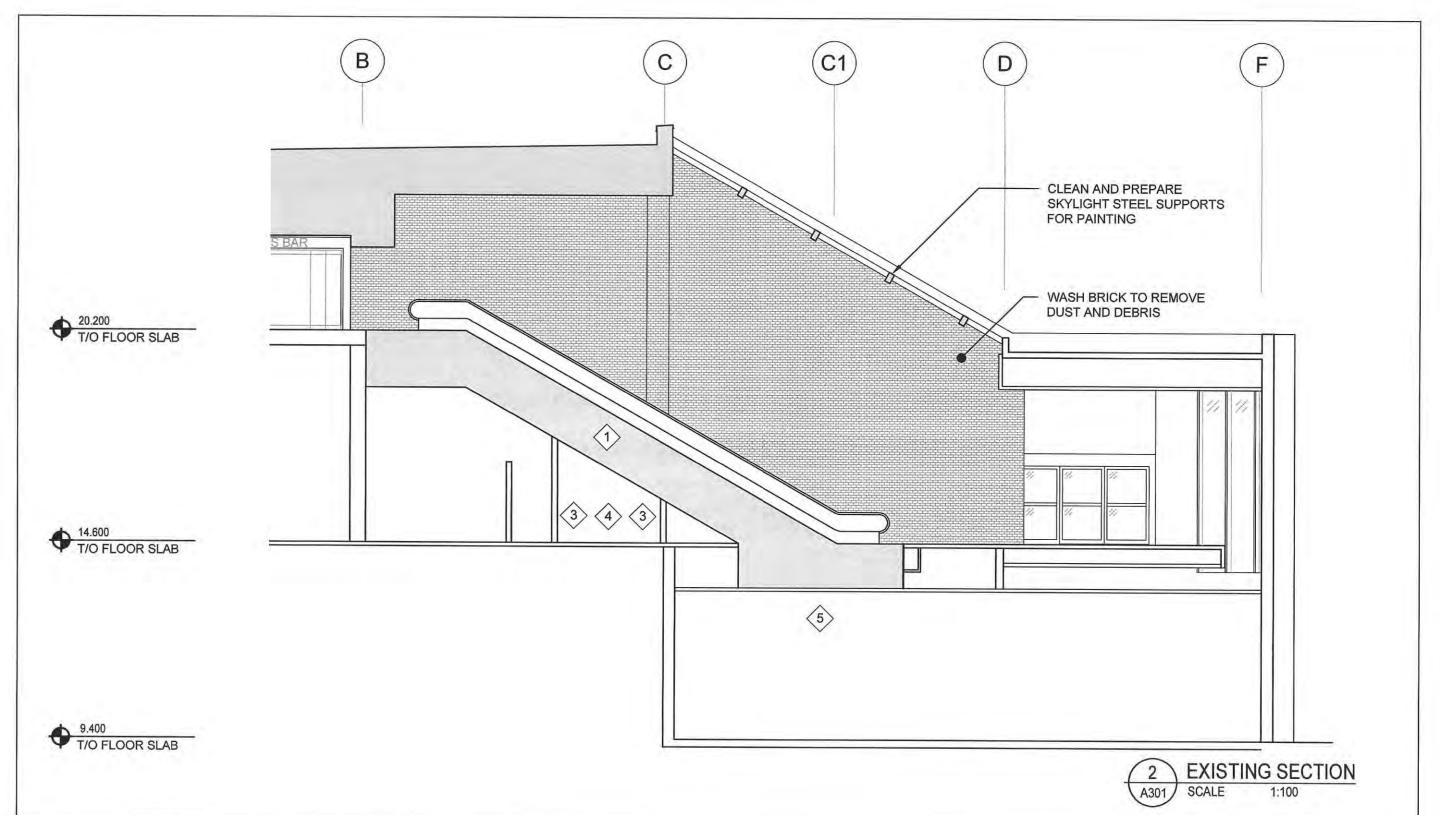





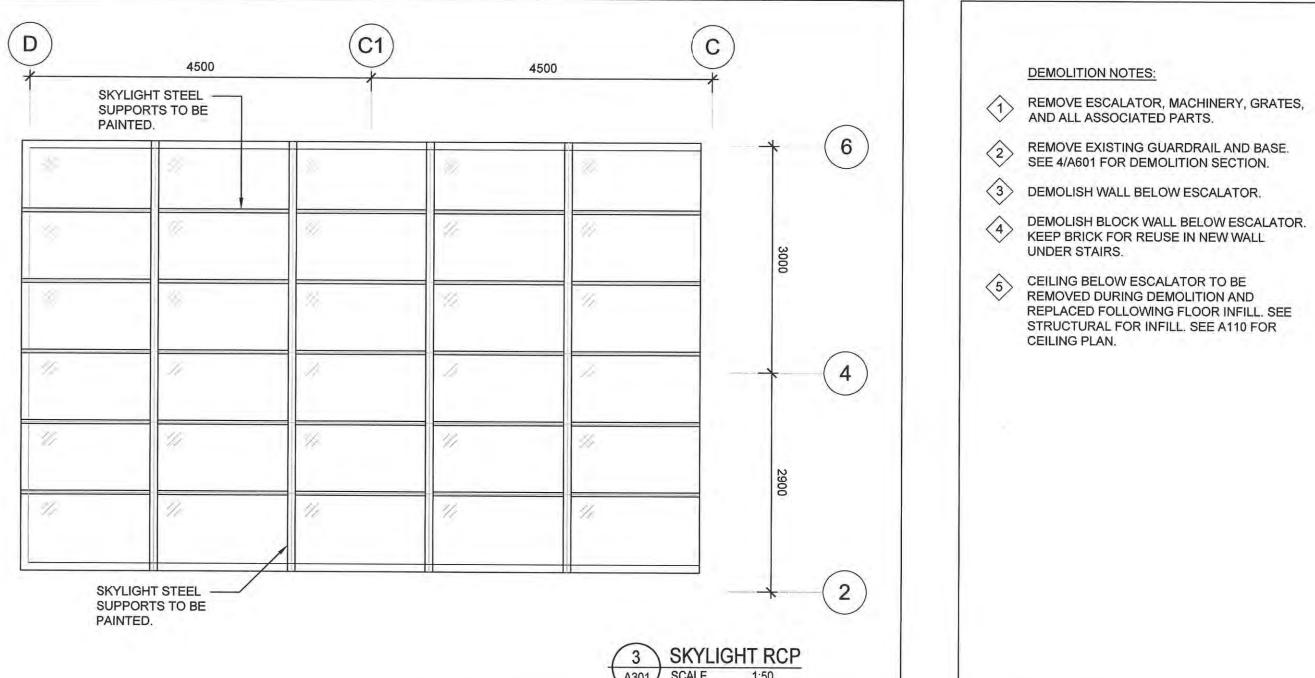



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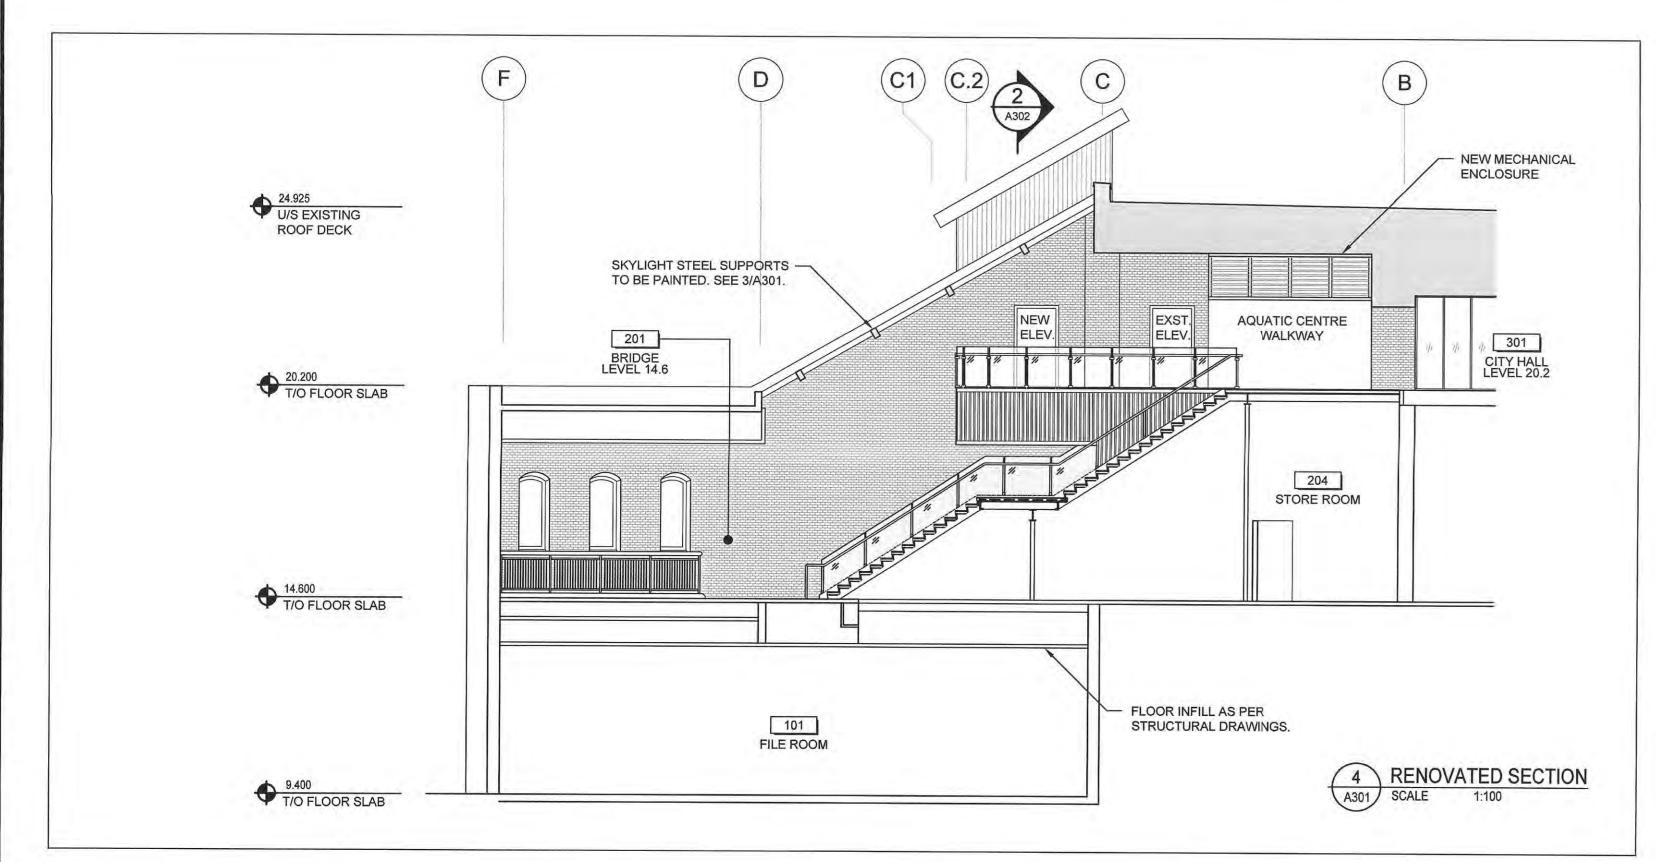


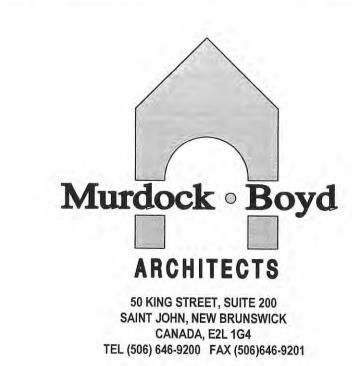




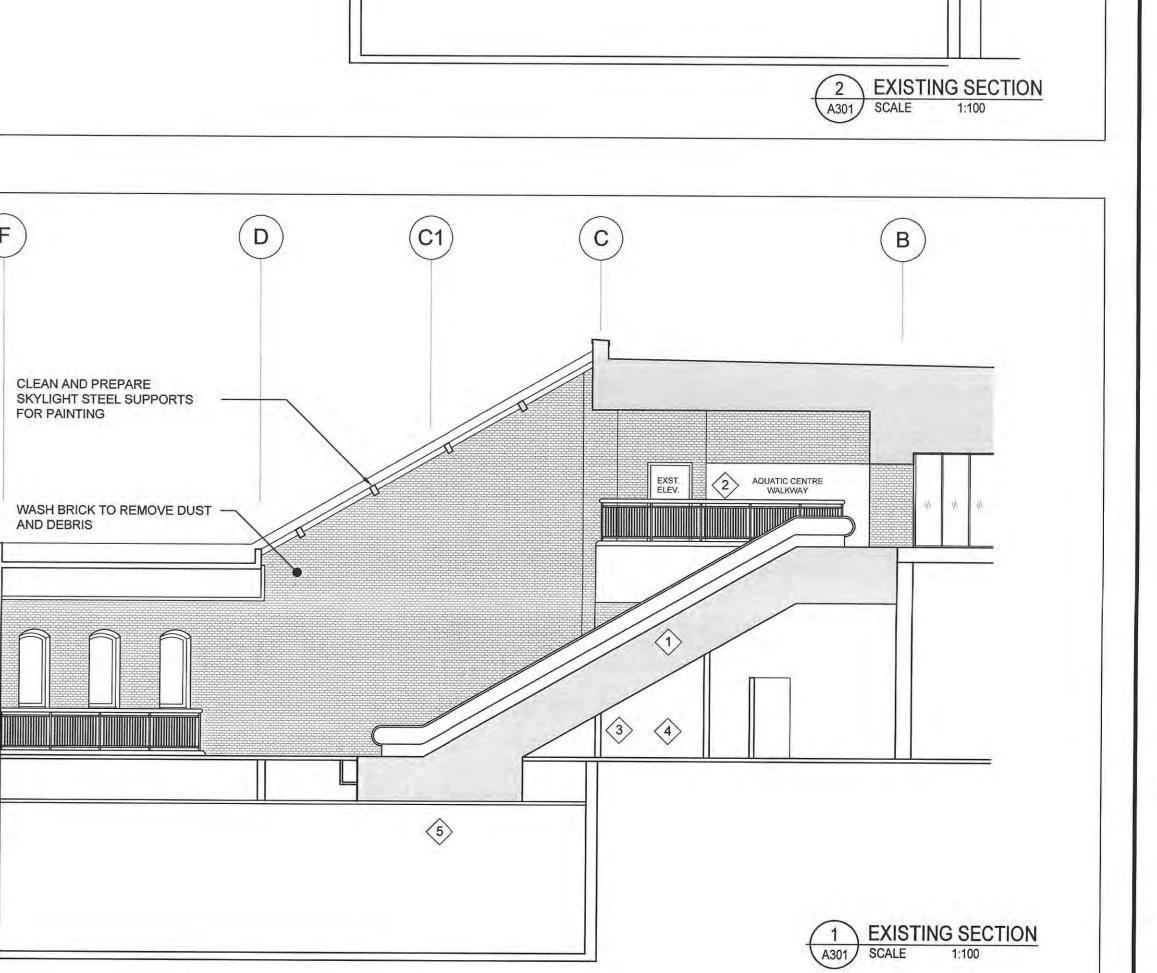

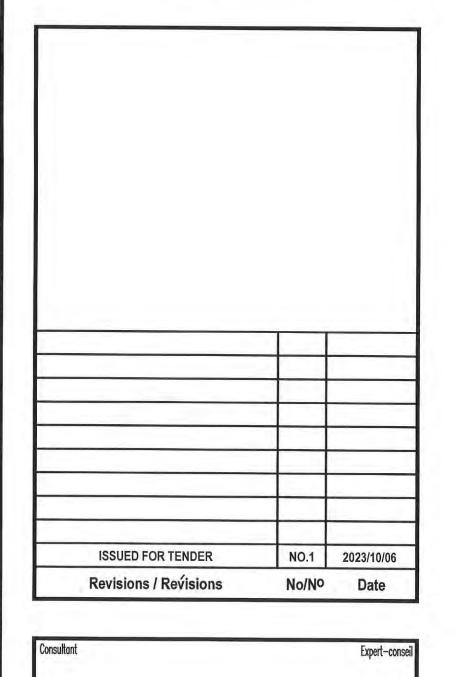
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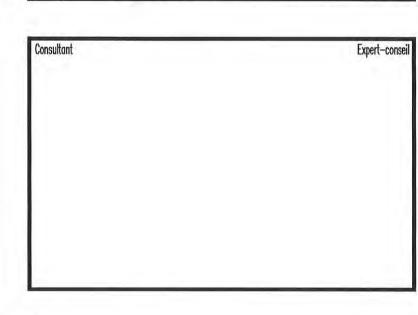


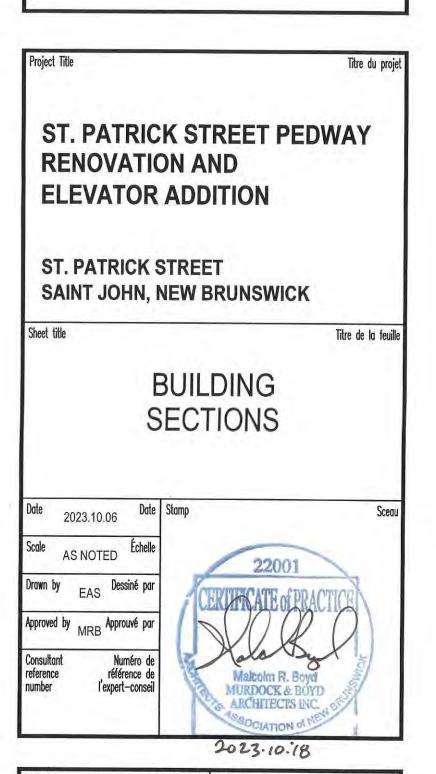

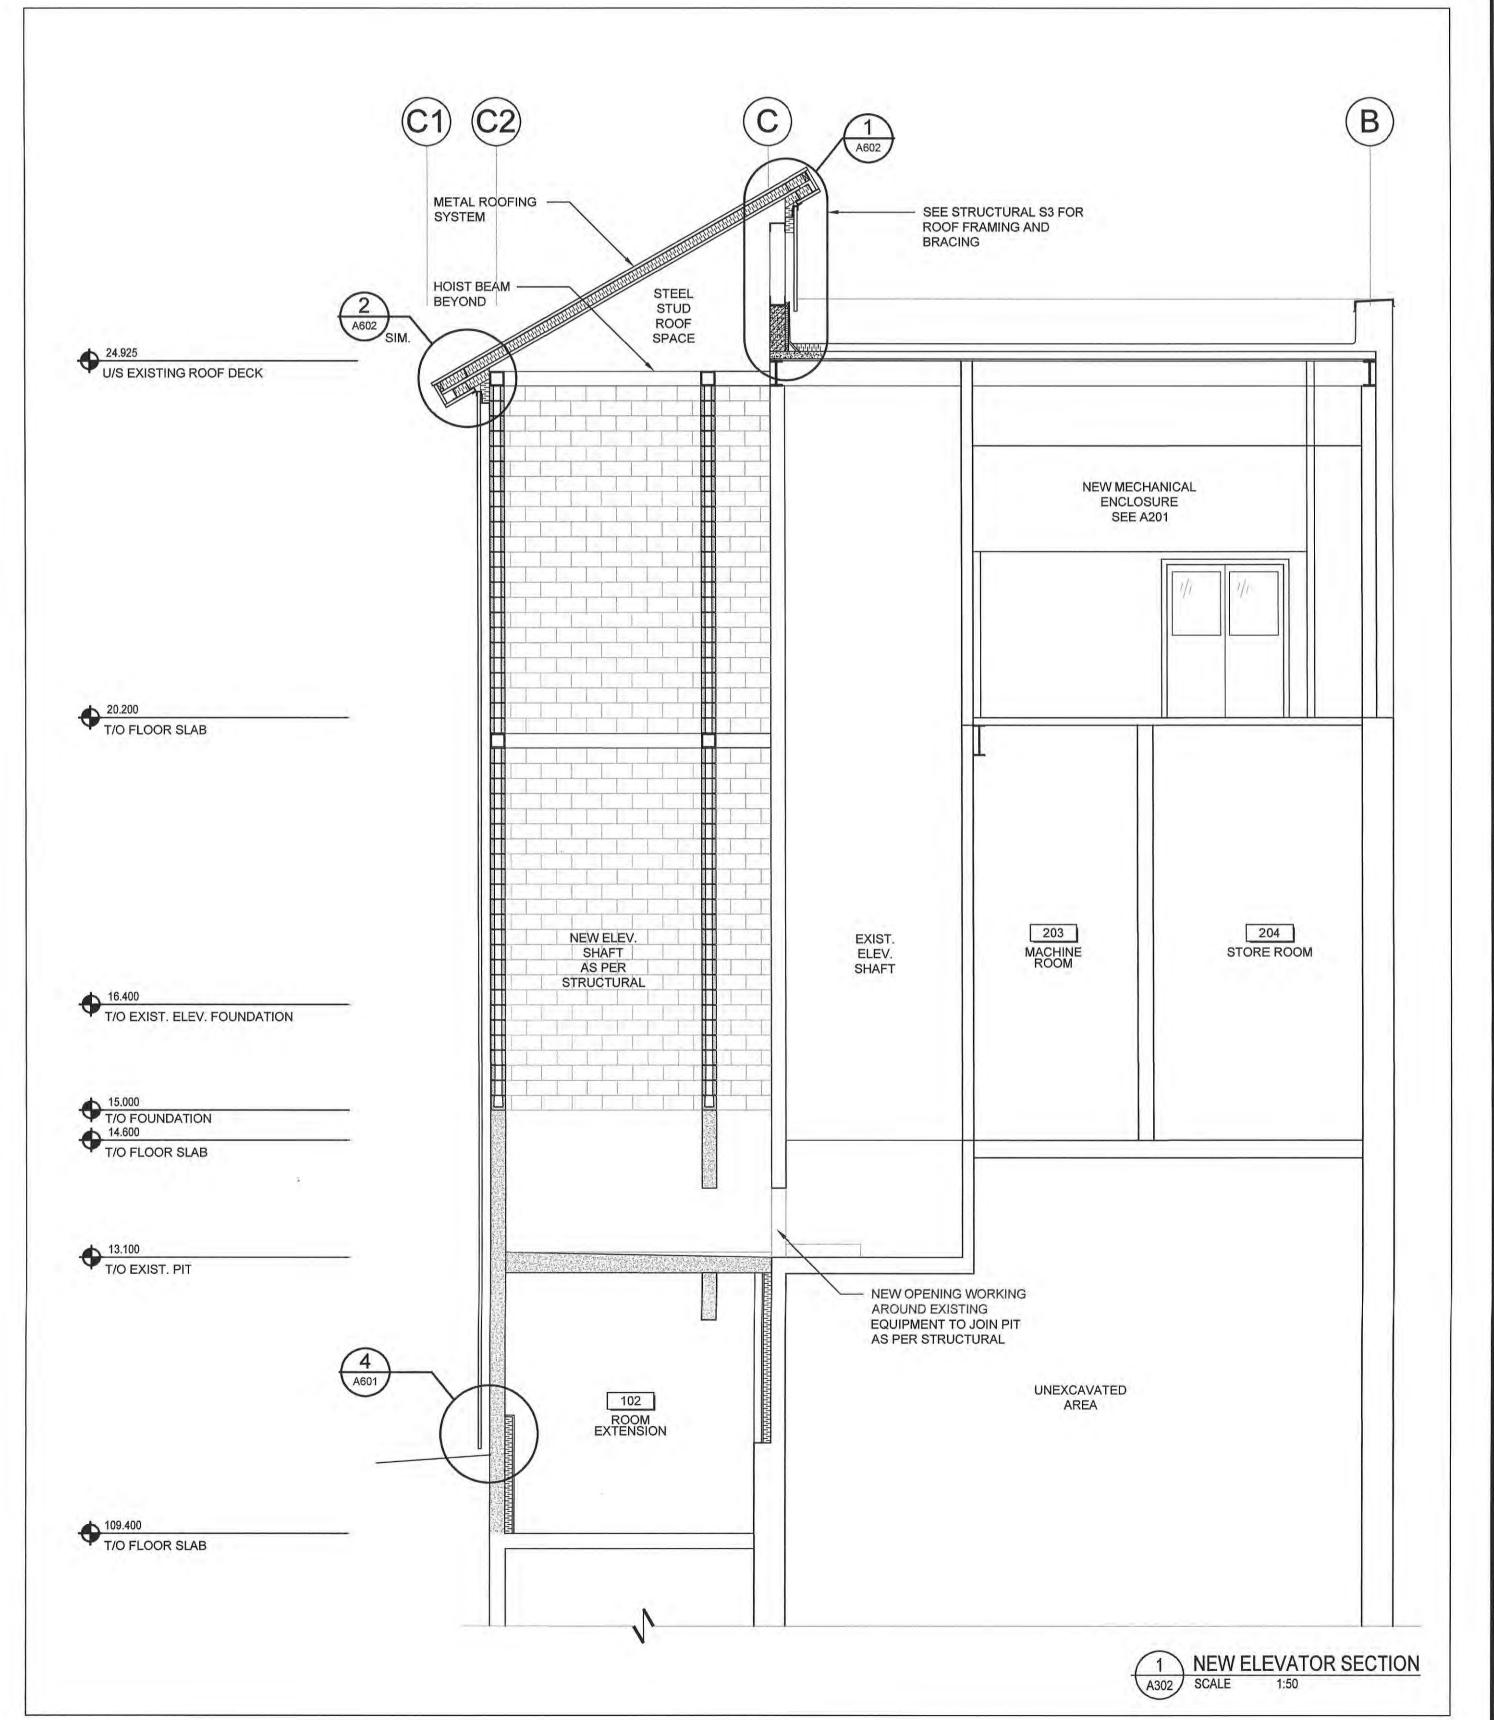

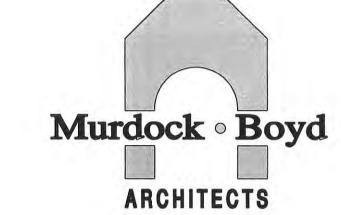


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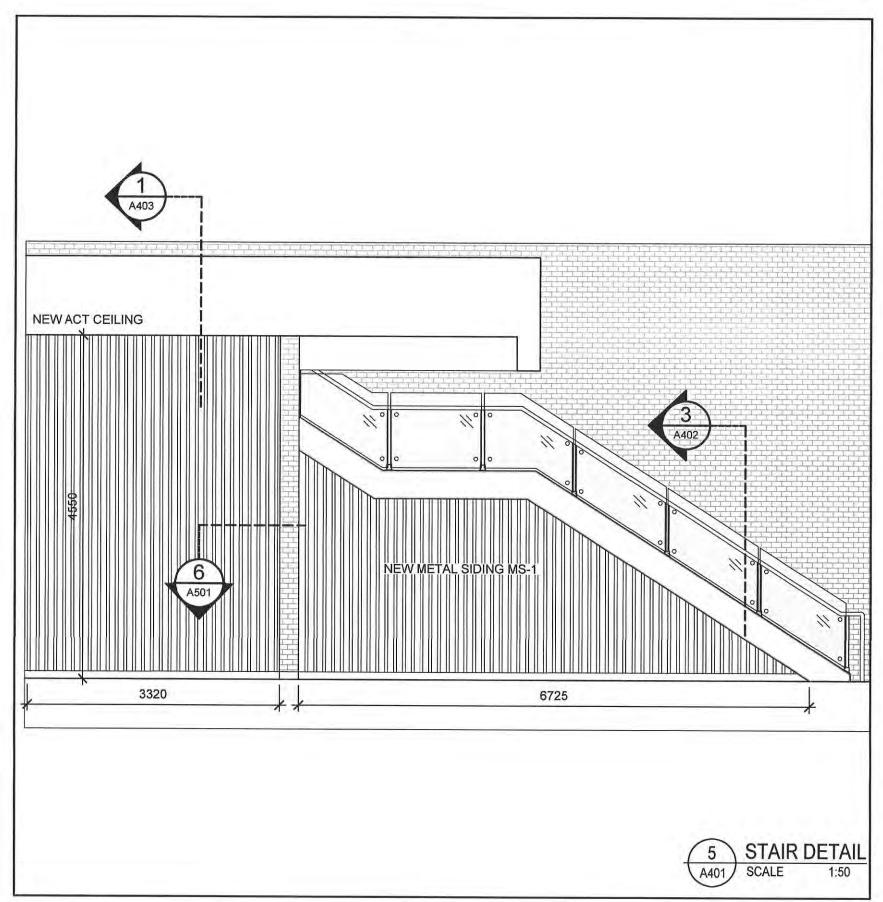



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| ST. PATRIC<br>RENOVATION<br>ELEVATOR                                |  |
| _ X 20 A  | NEW BRUNSWICK                                  |
| Sheet title   | Titre de la feuil                              |
|   | WALL   |
| S   | ECTIONS  |
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| Scale 1:50 Échelle  | 22001  |
| Drawn by EAS Dessiné par  | CERTIFICATE OF PRACTICE                        |
| Approved by MRB Approuvé par  | 0000   |
| Consultant Numéro de reference référence de number l'expert-conseil | Malcoln R. Boyd MURDOCK & BOYD ARCHITECTS INC. |


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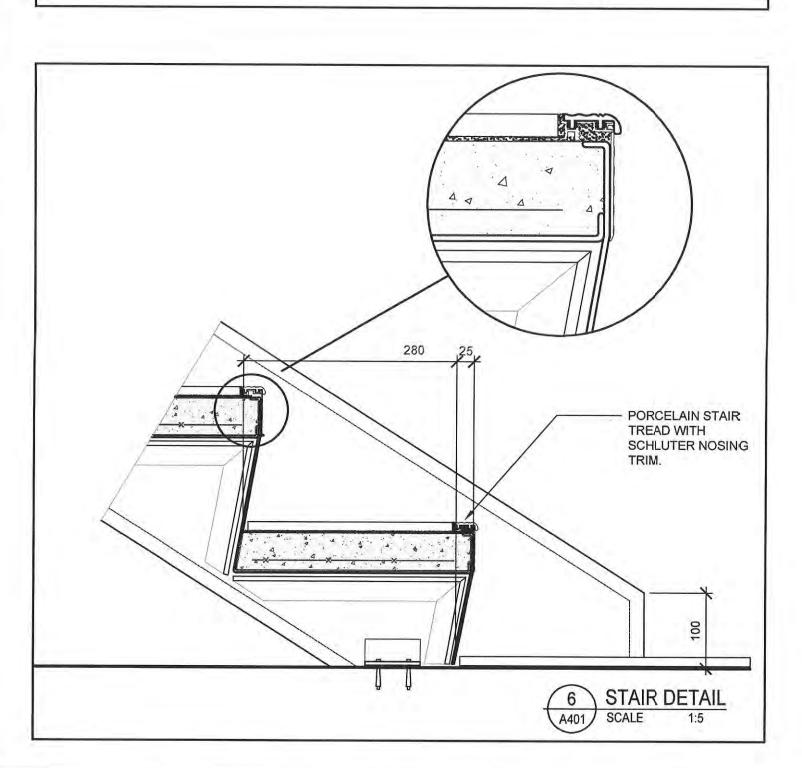
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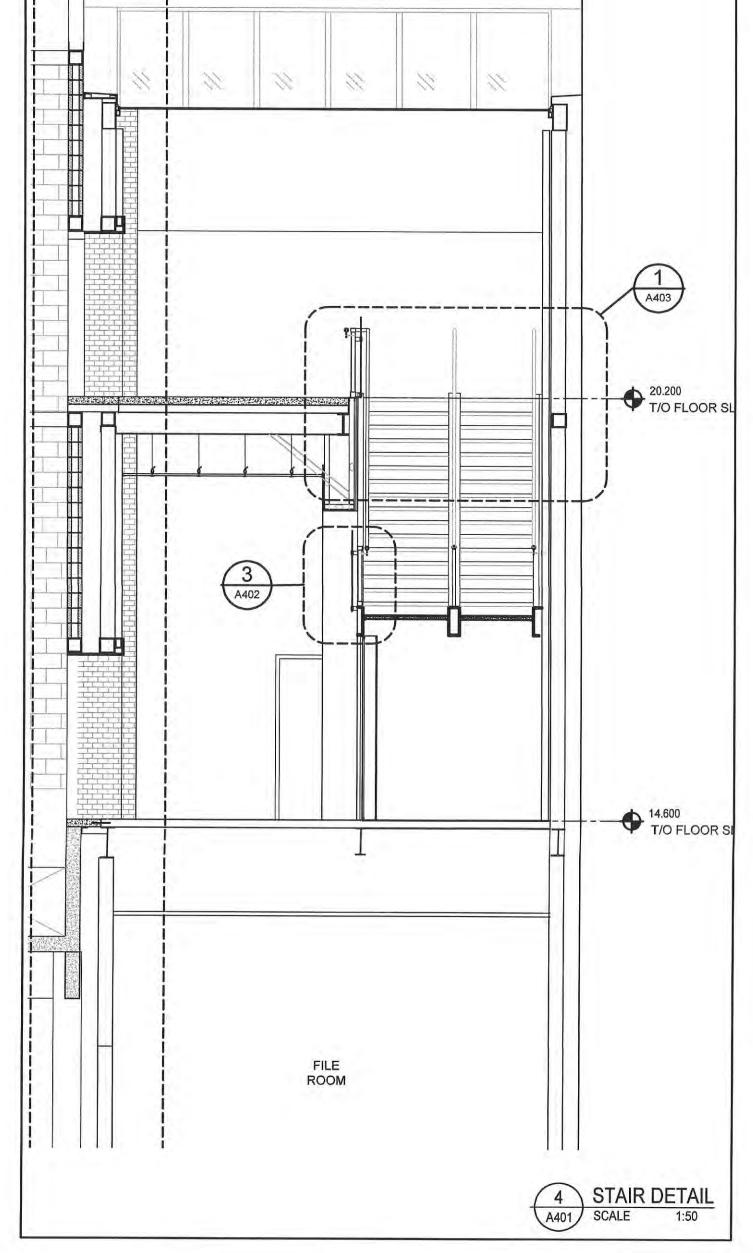







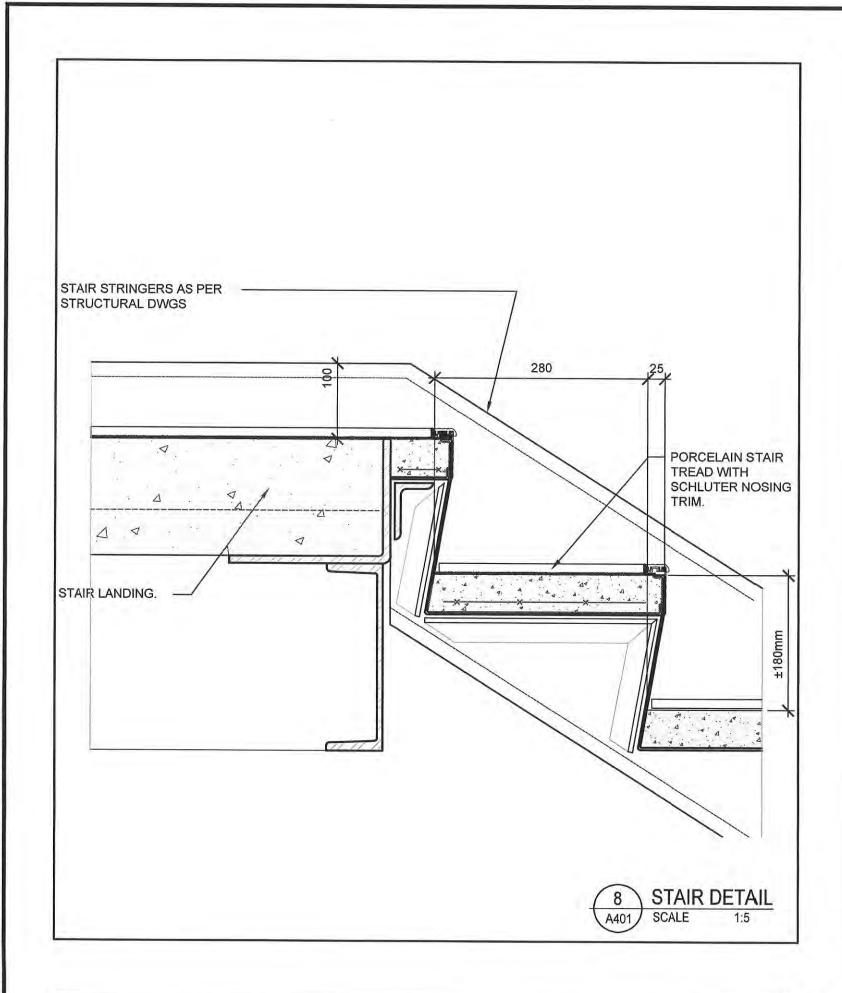


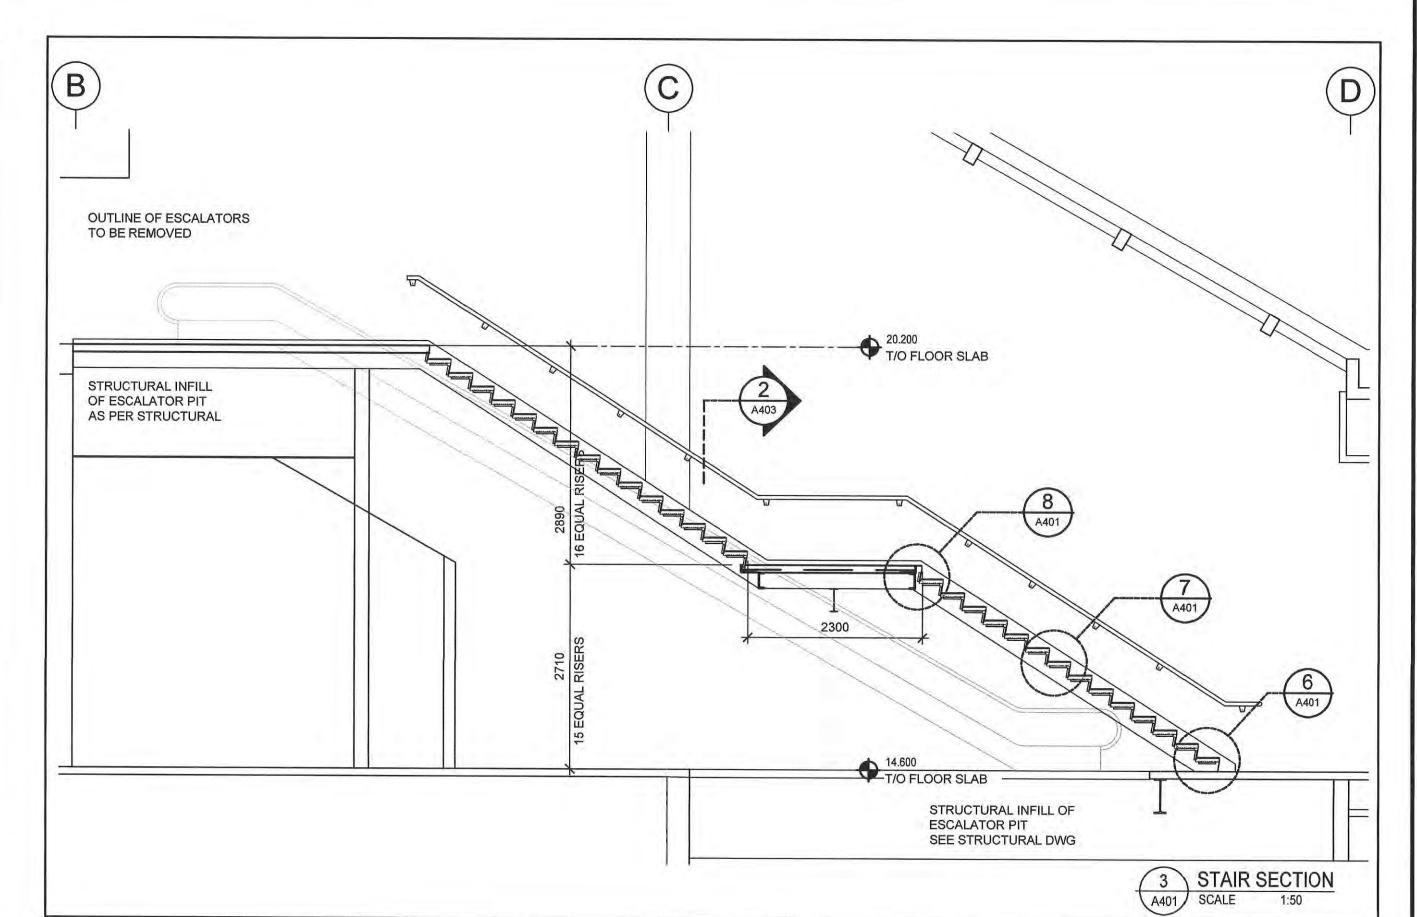

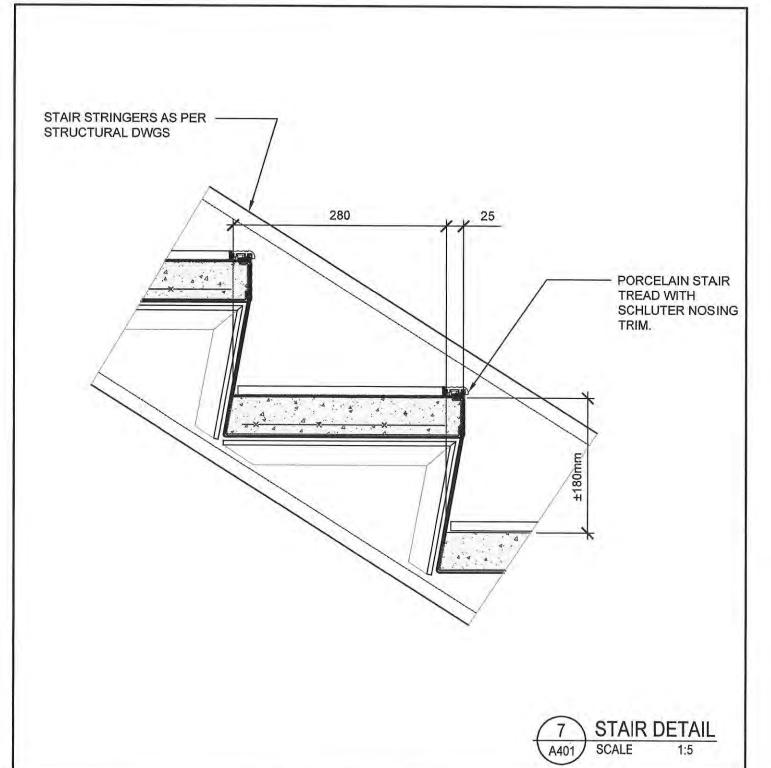



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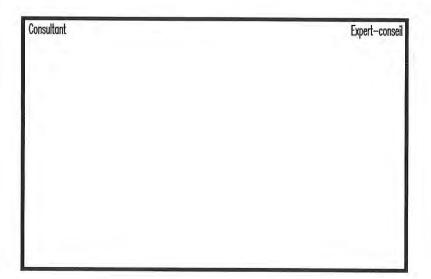


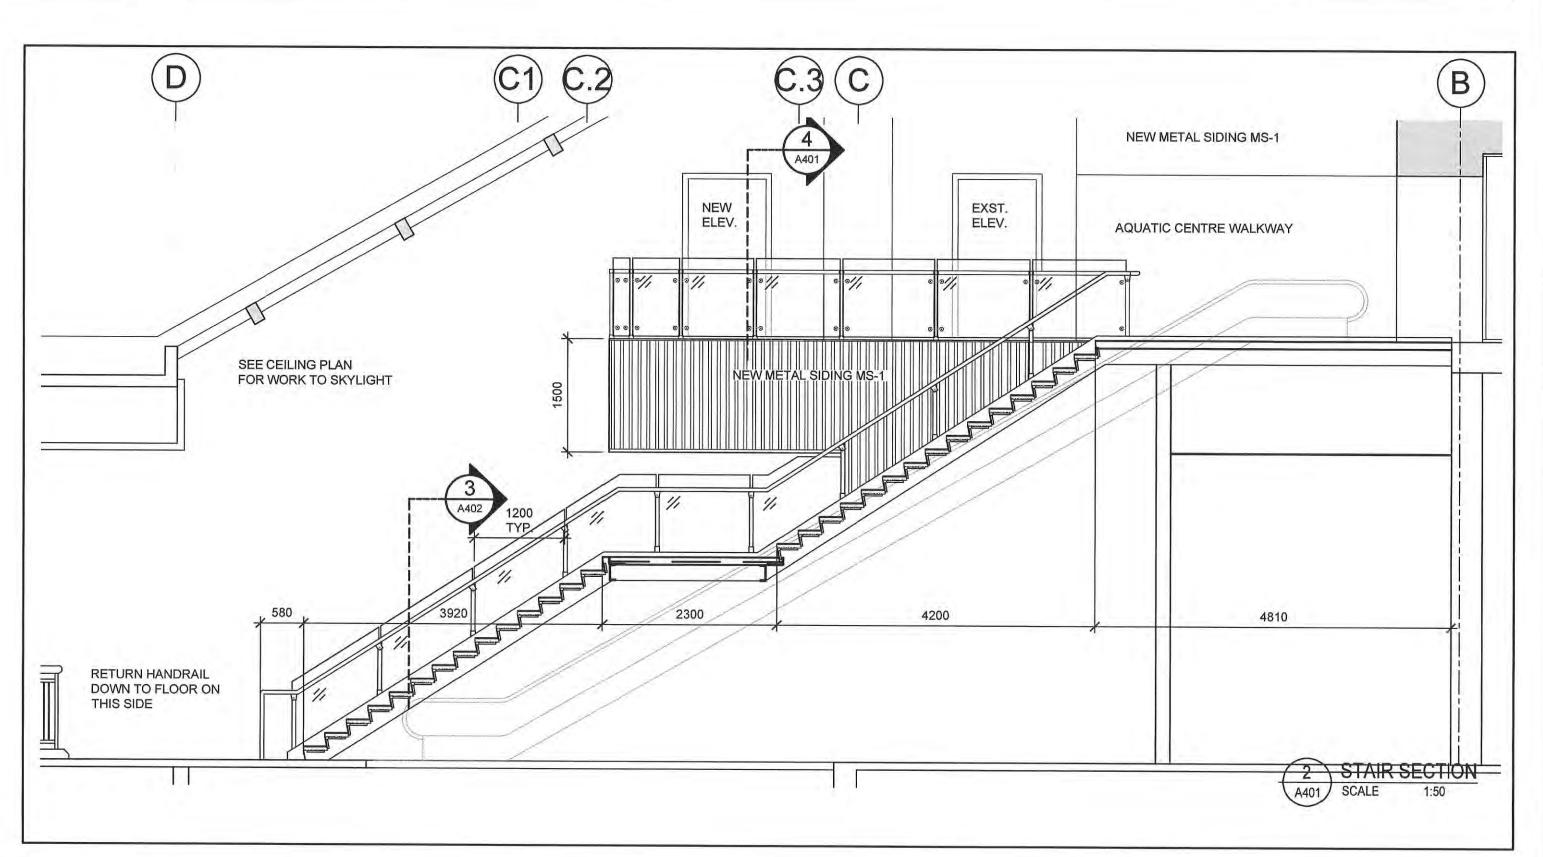

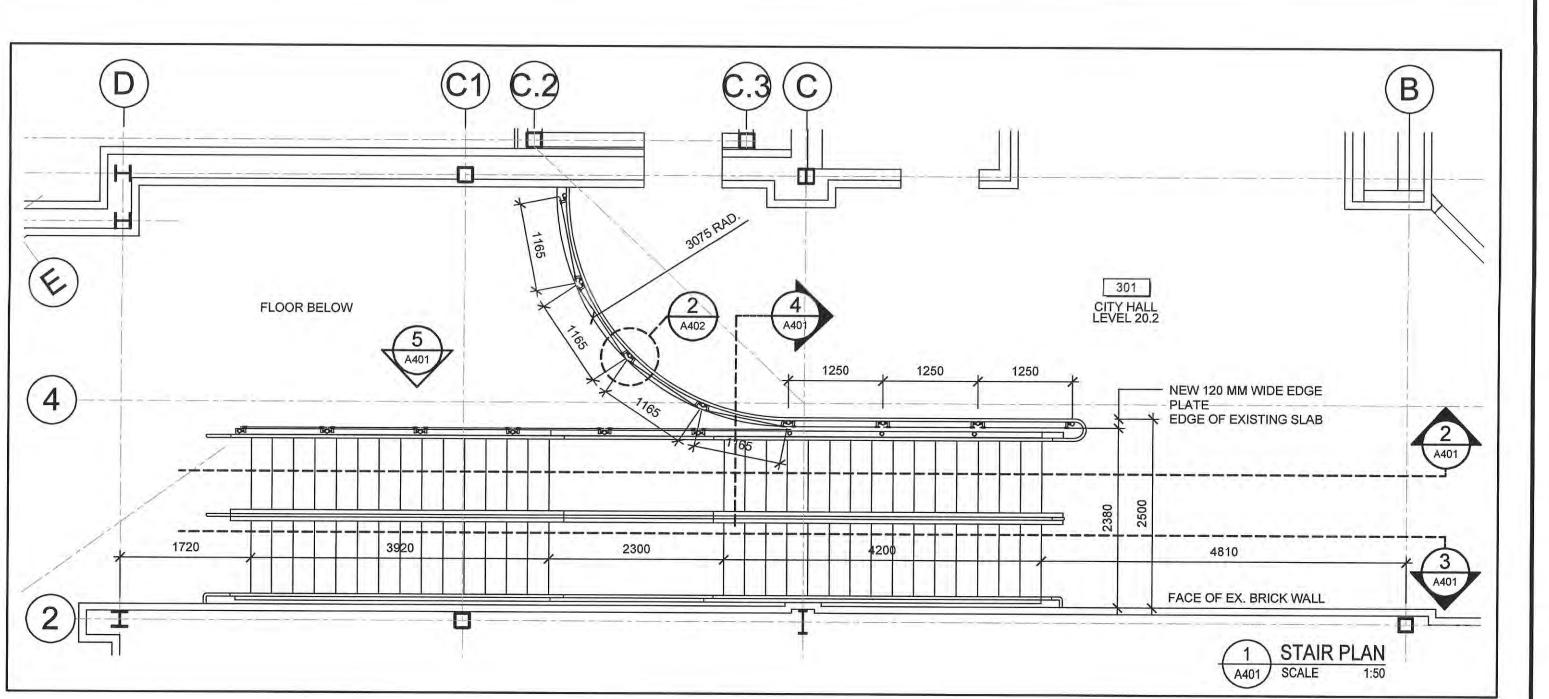



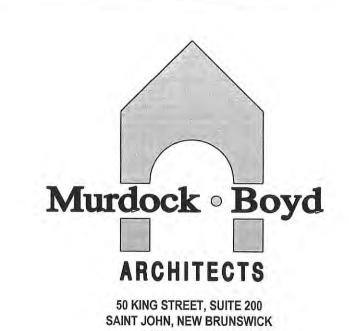

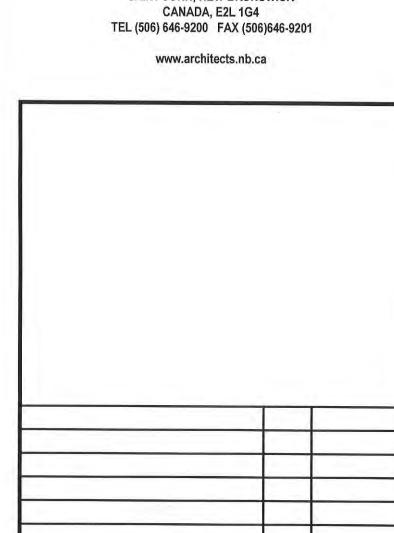


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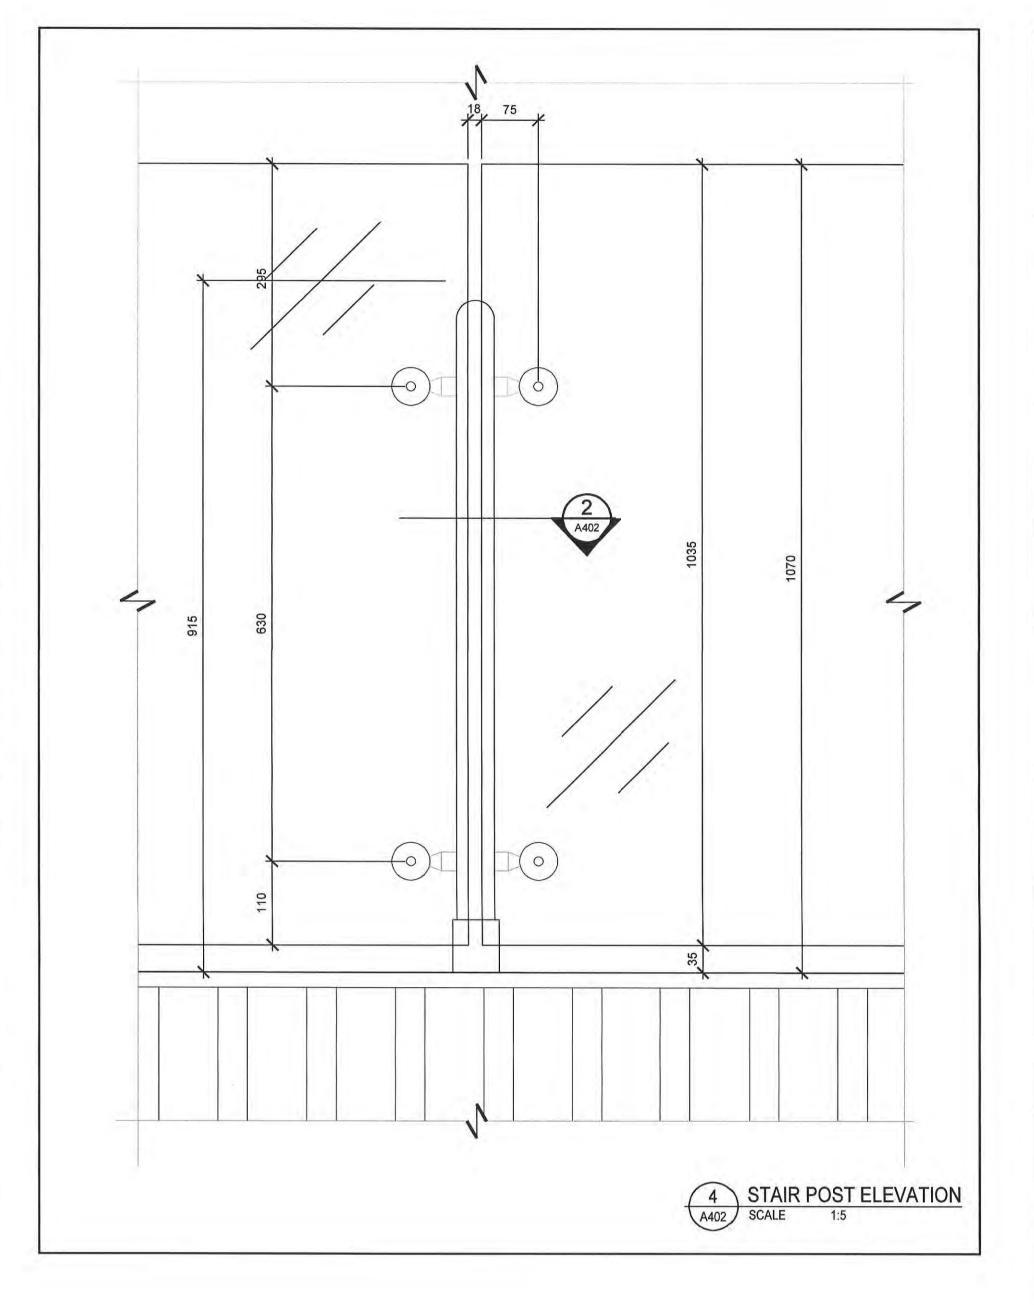
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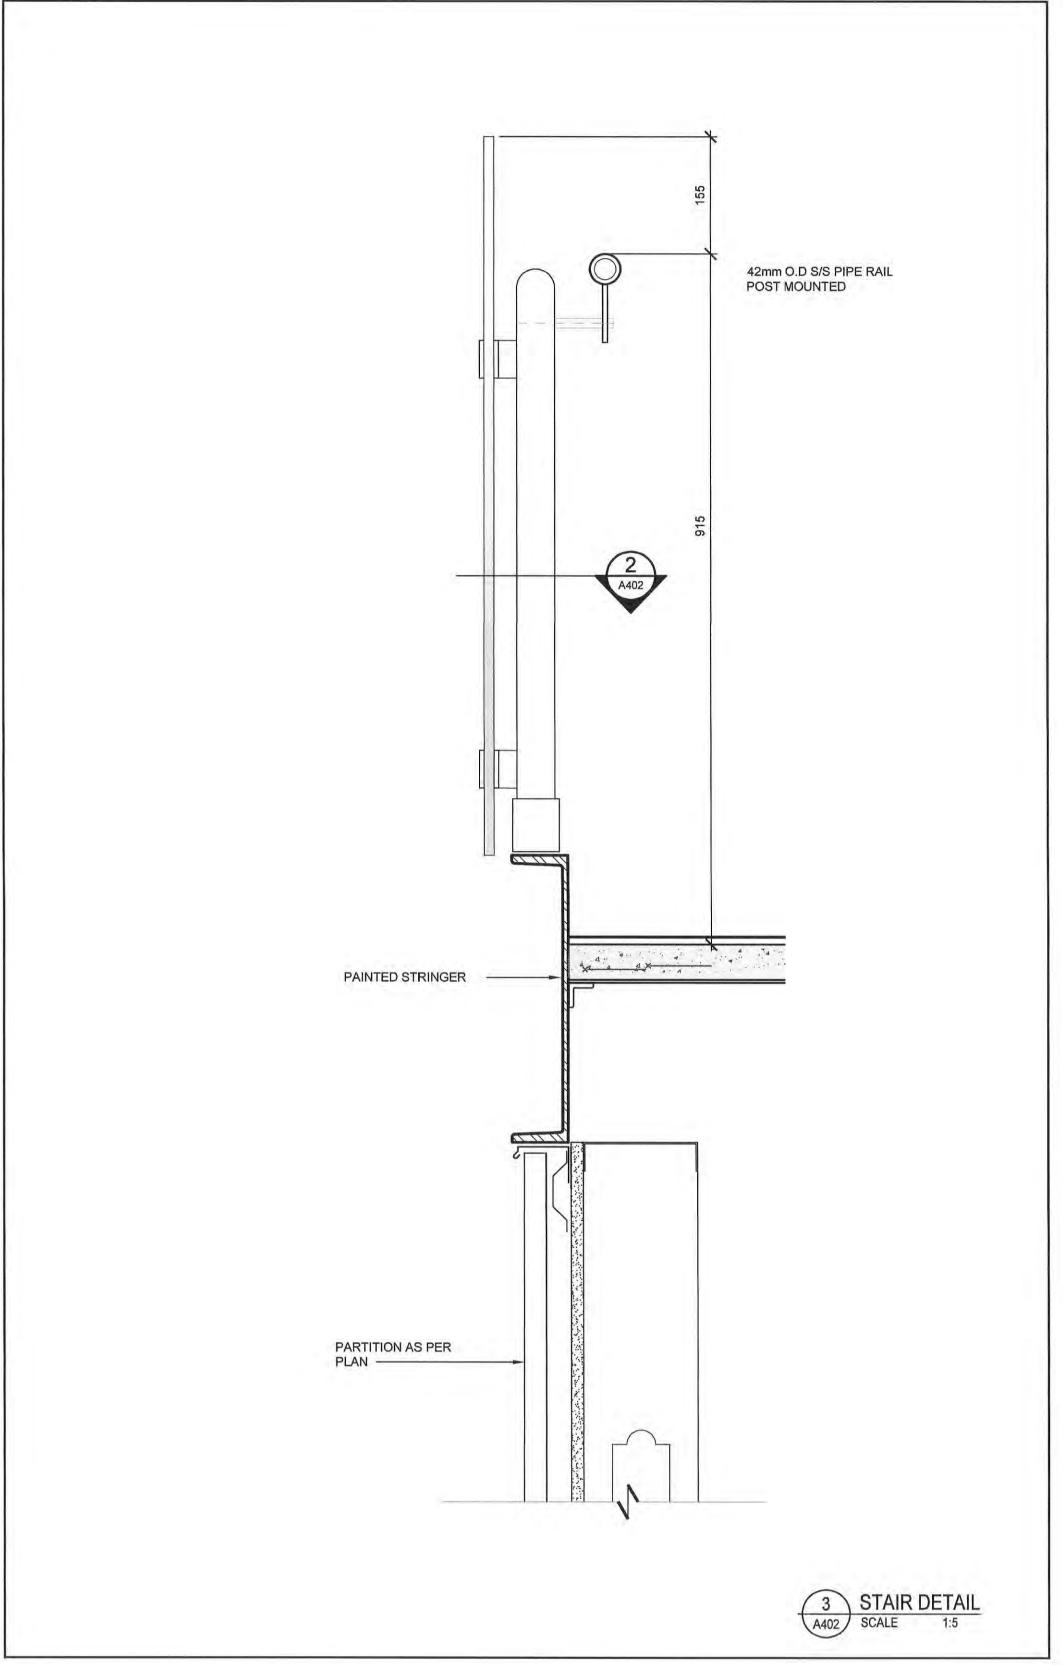
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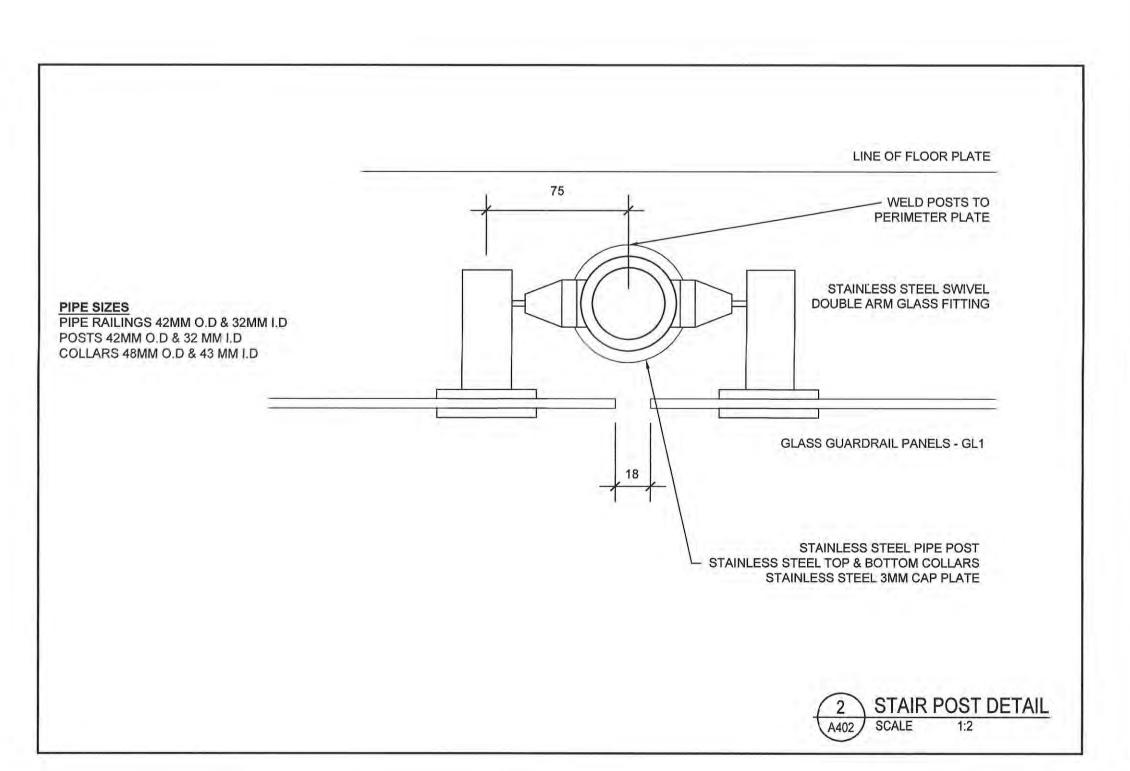
Revisions / Revisions




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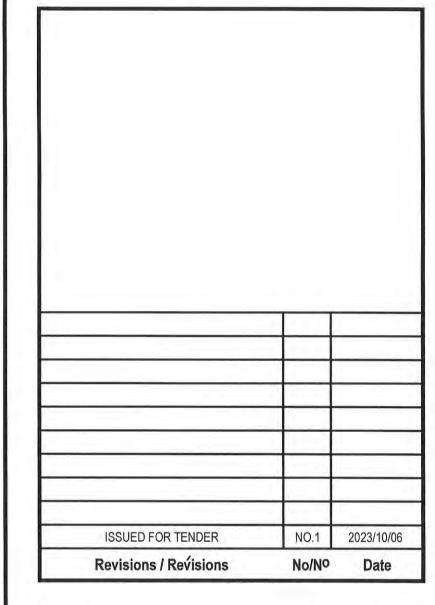





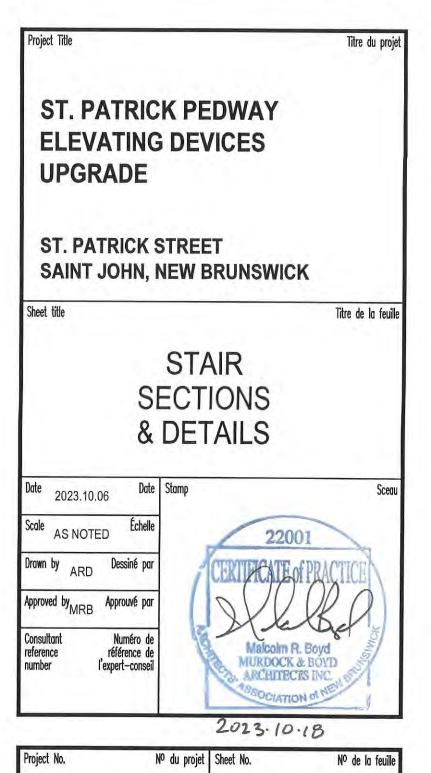


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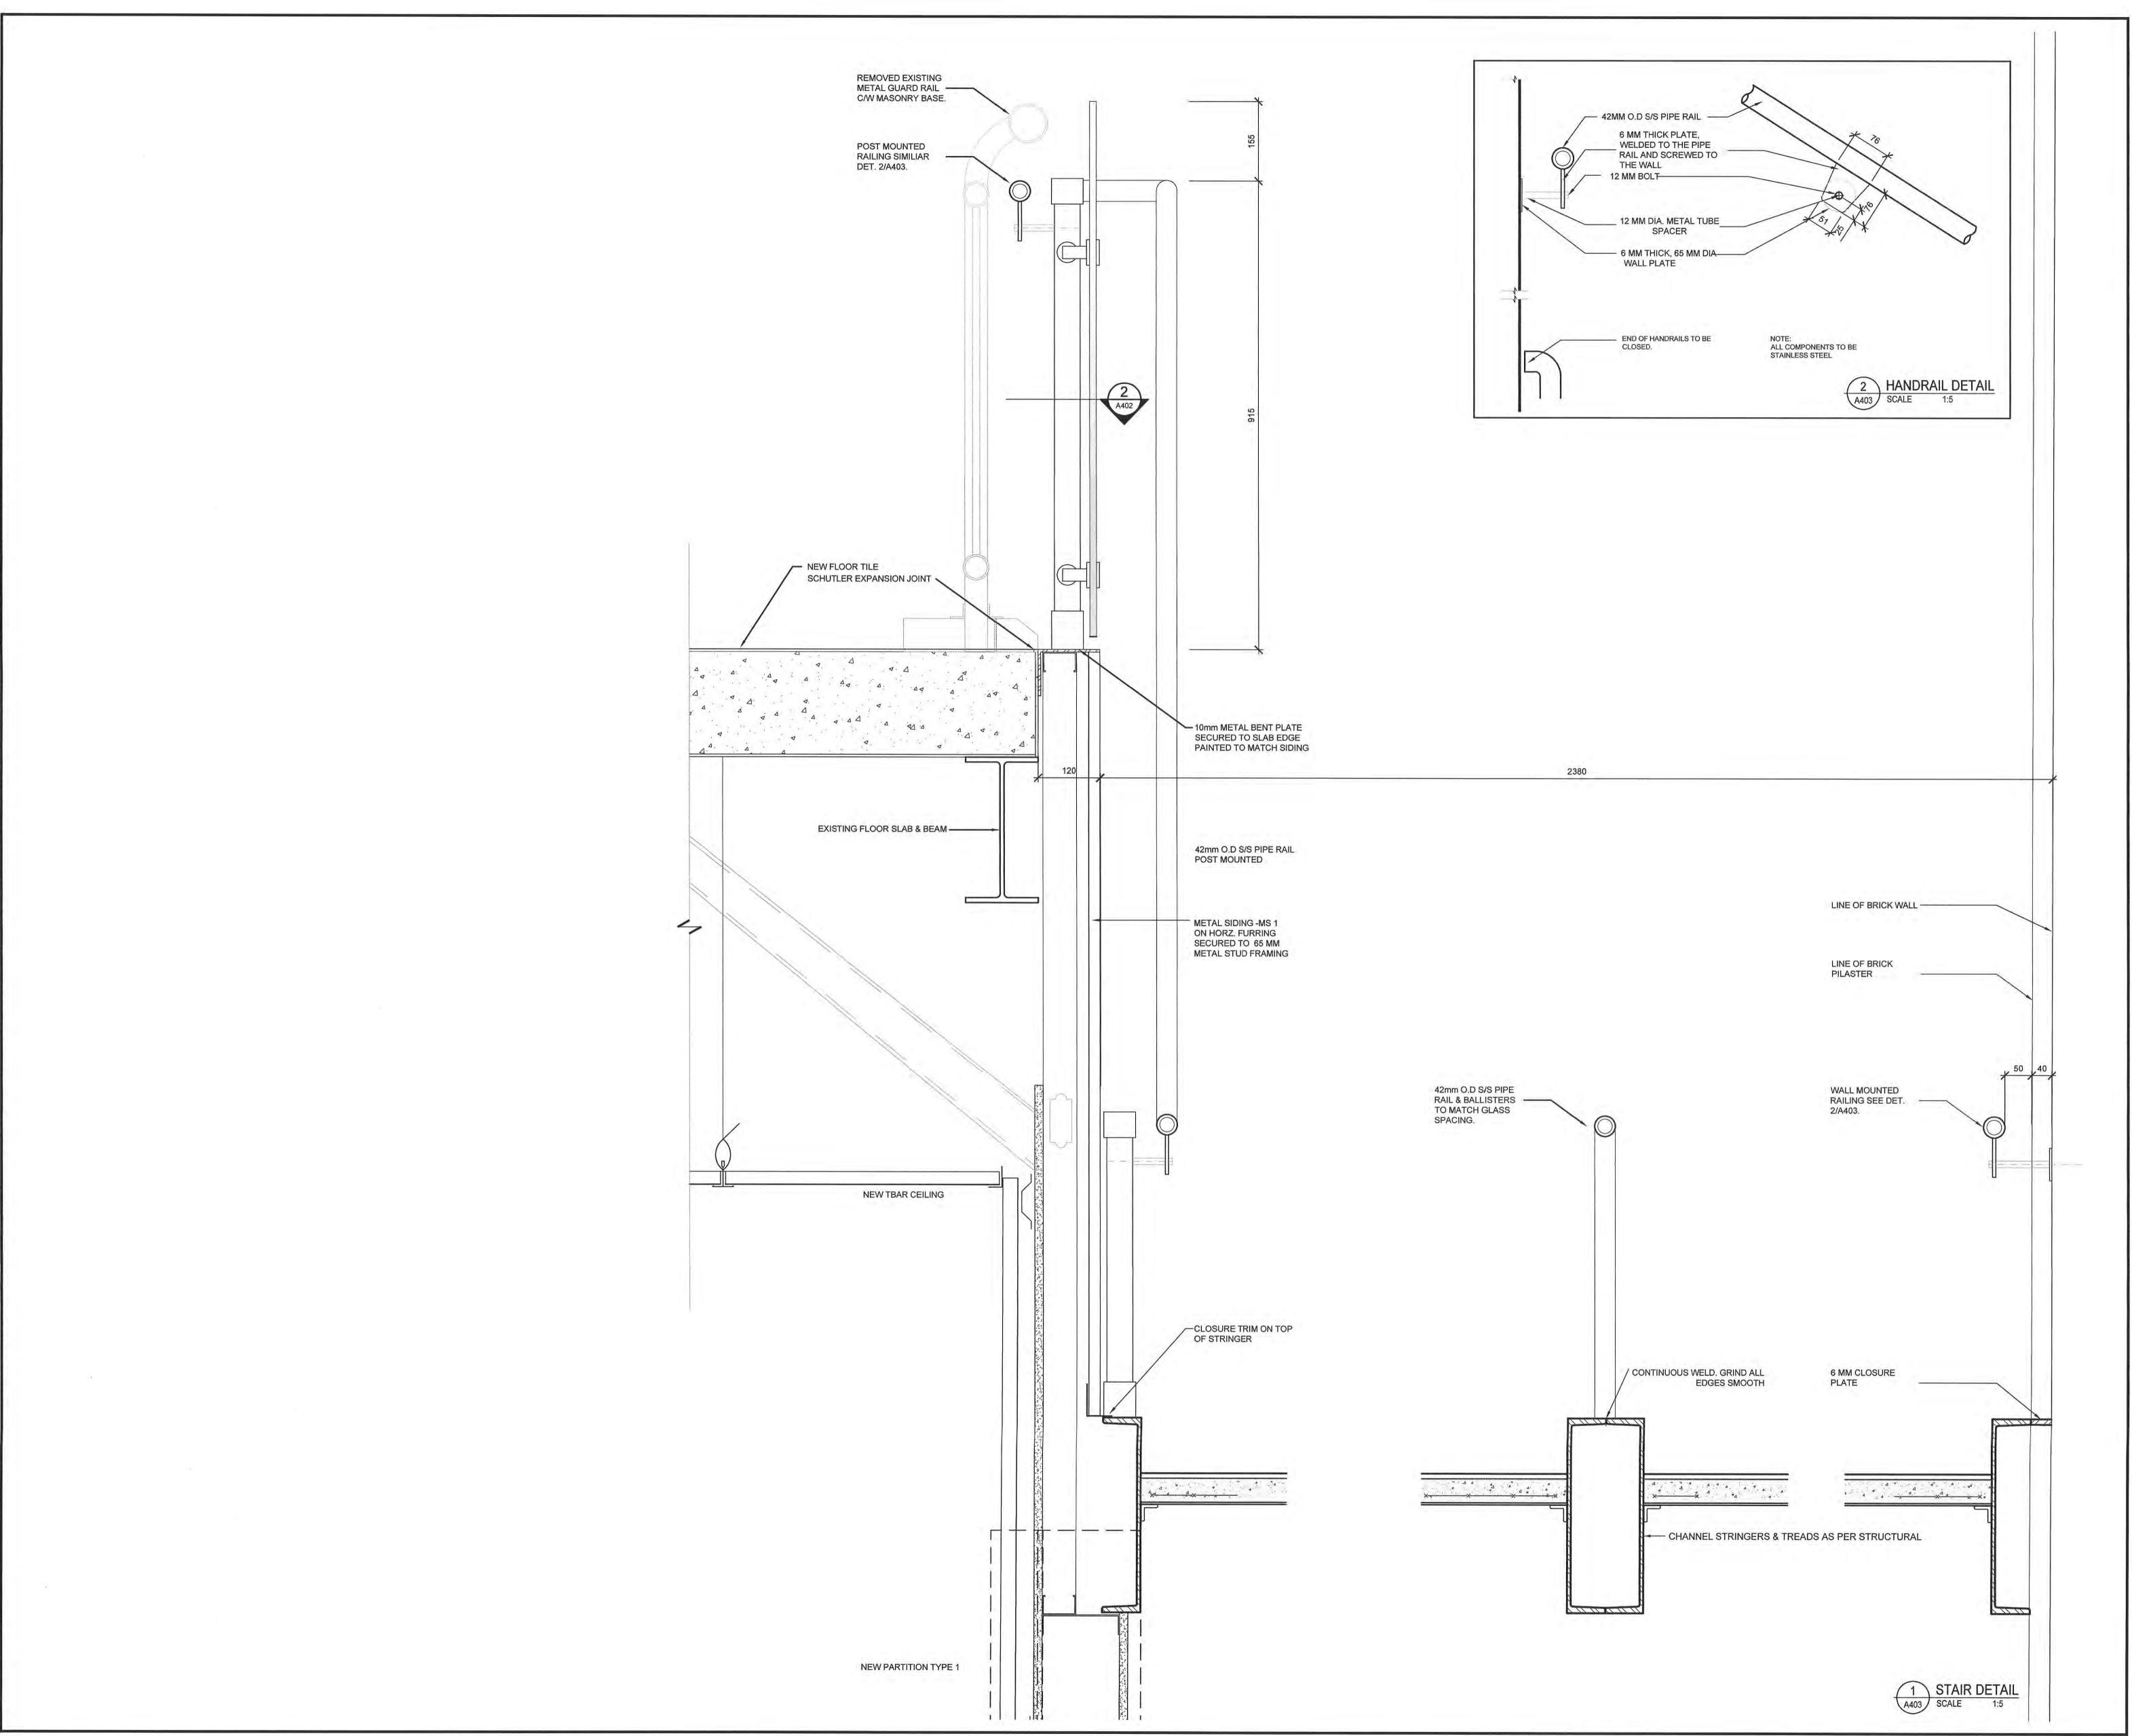
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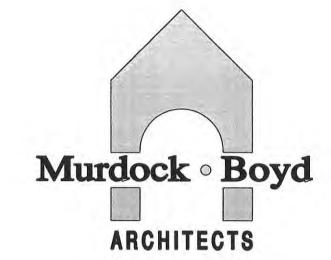


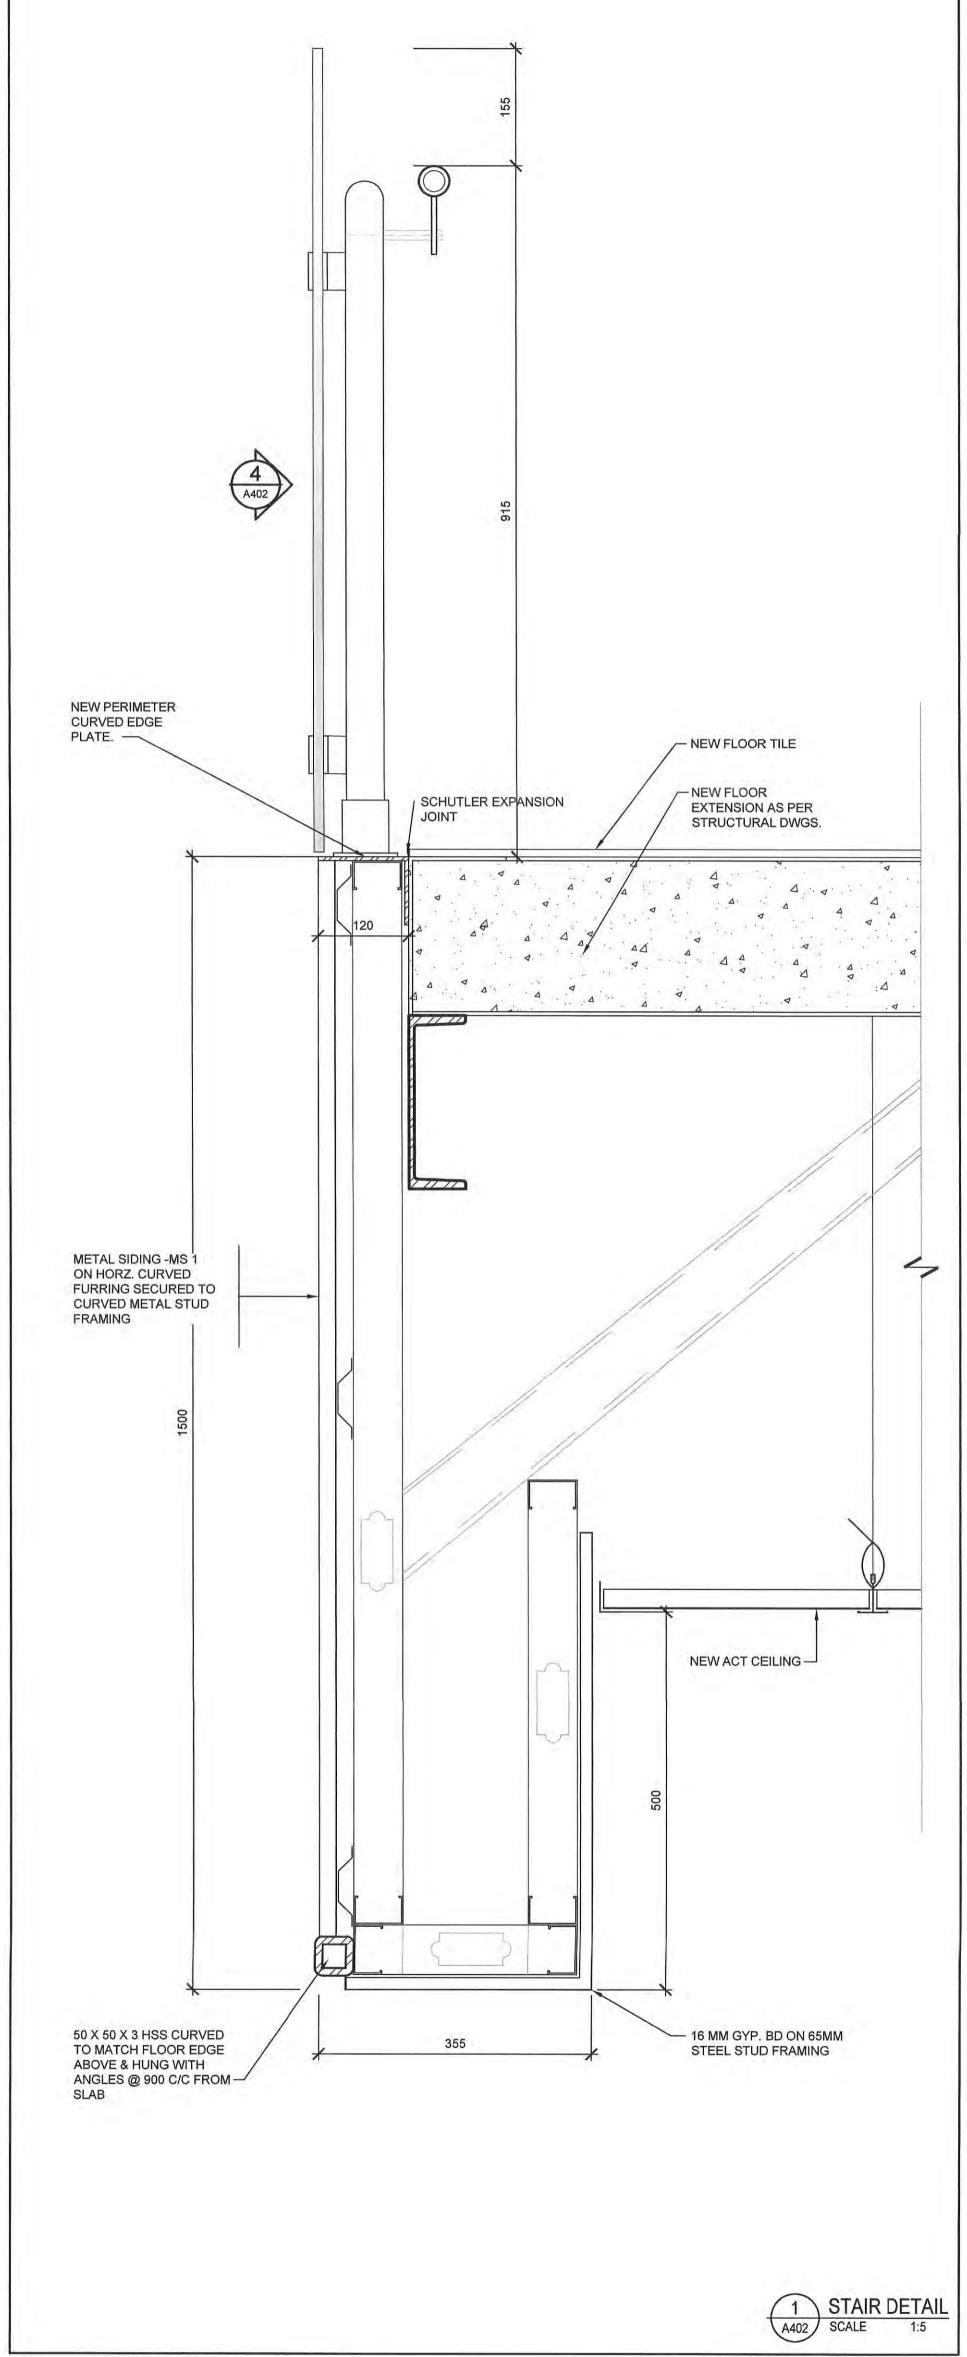


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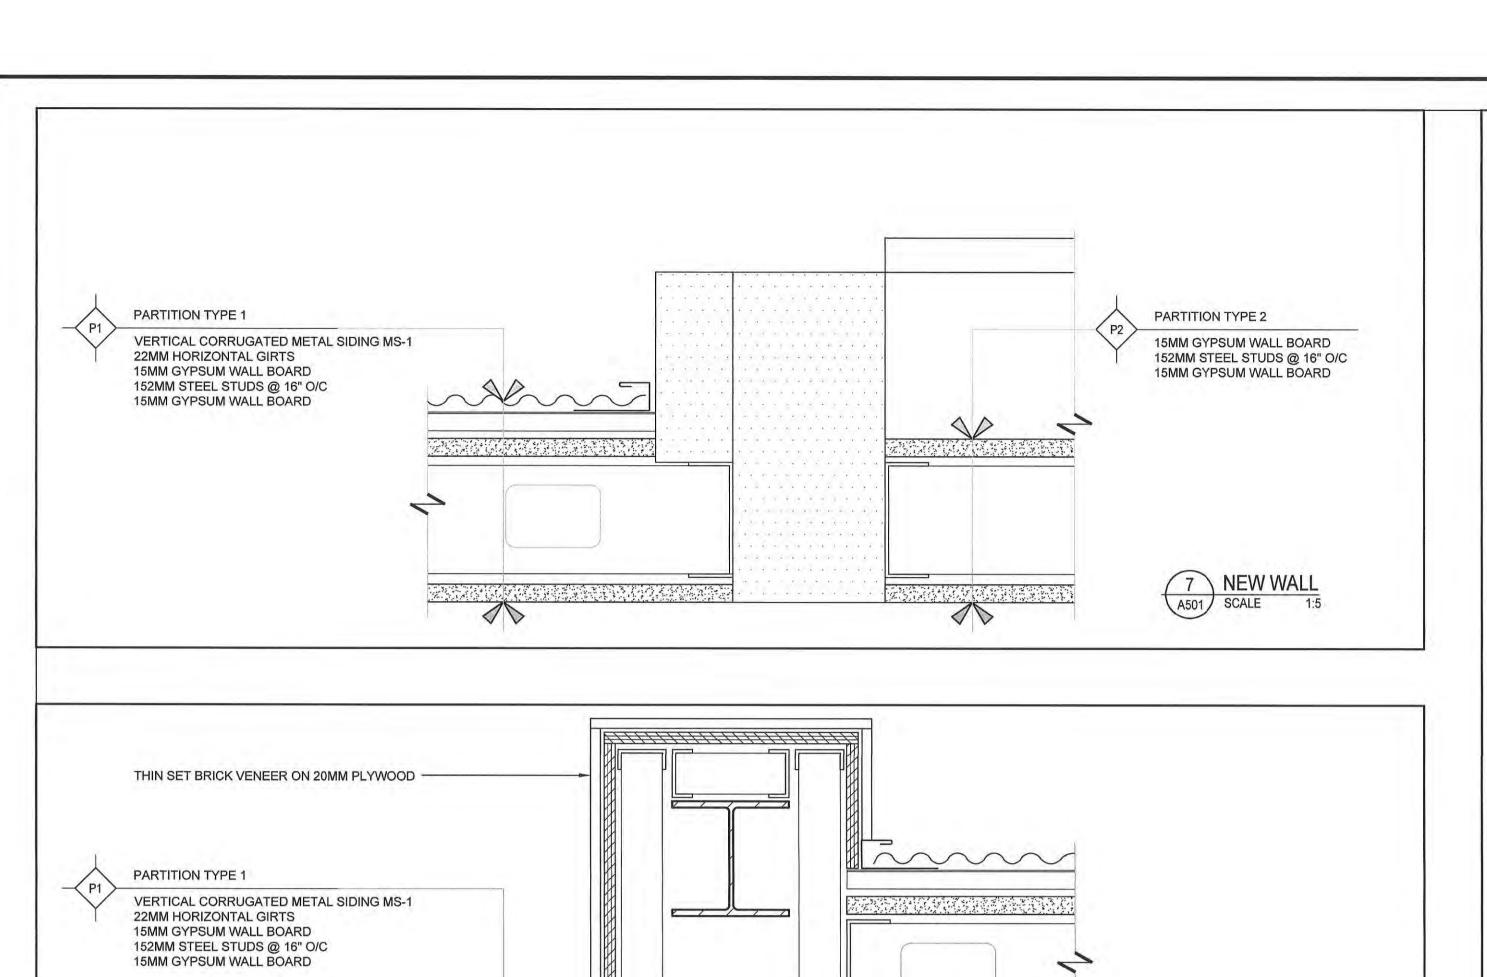

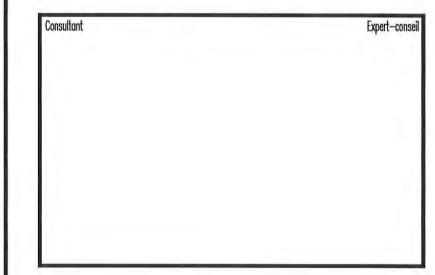
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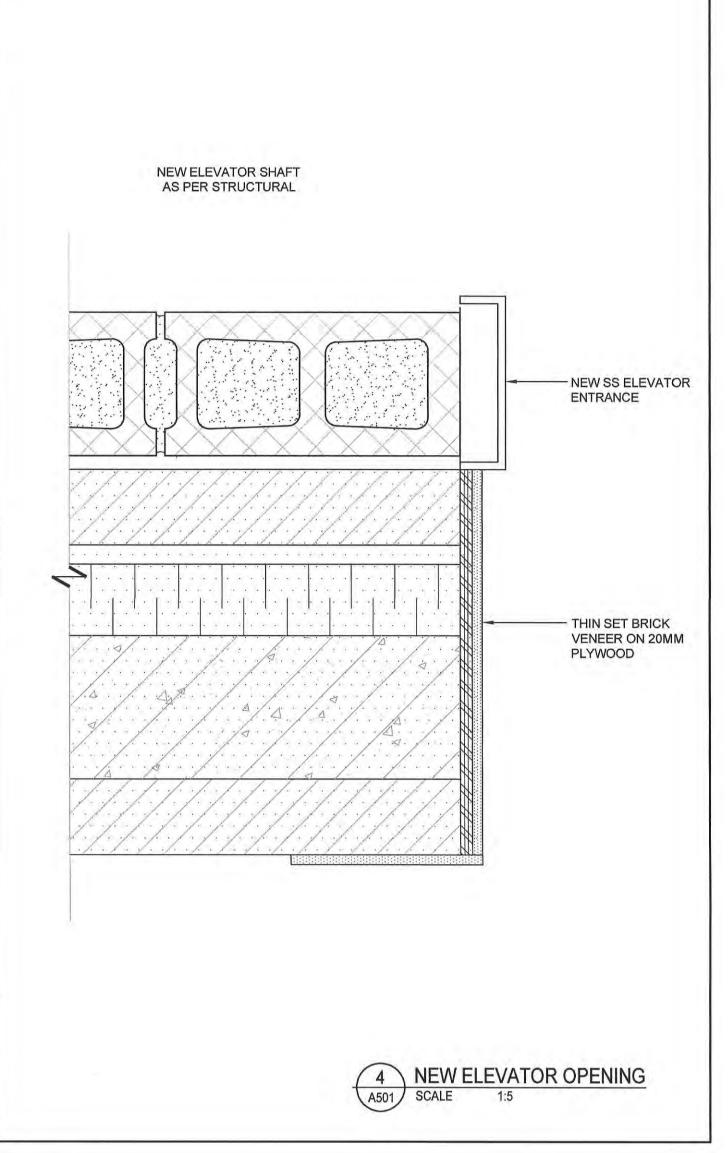
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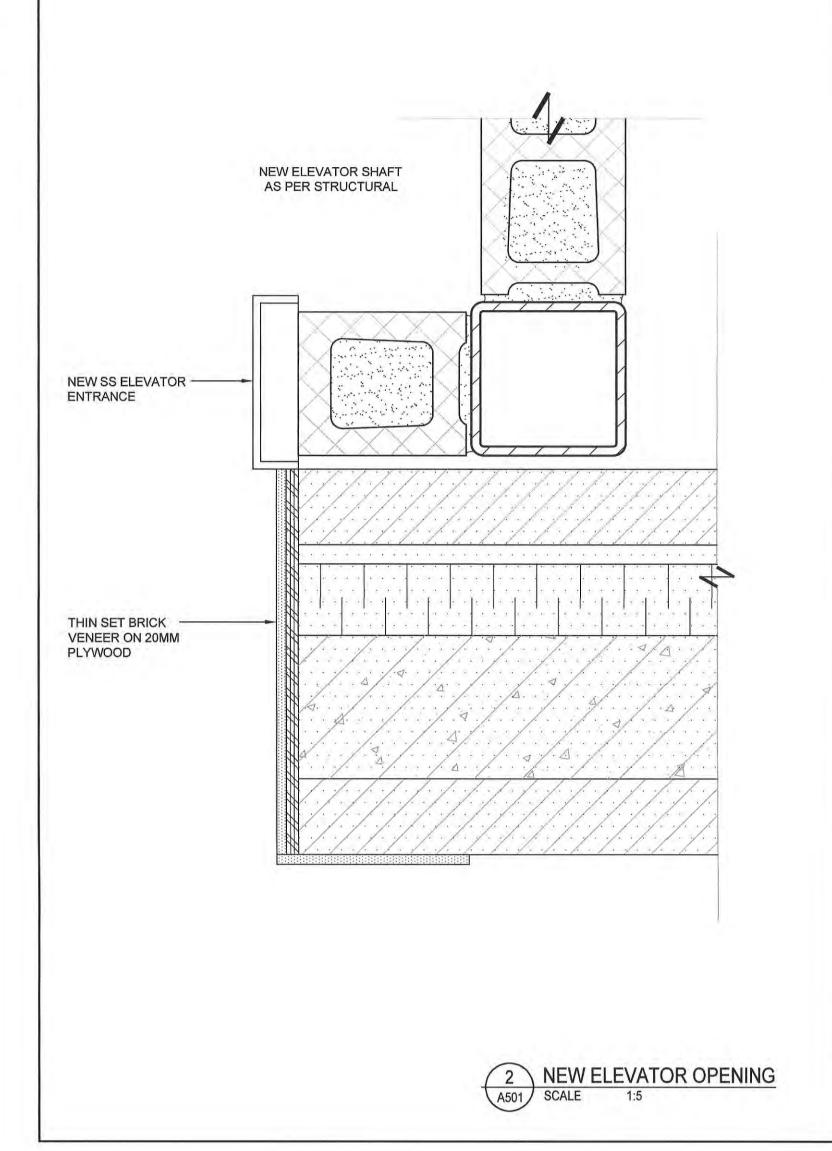
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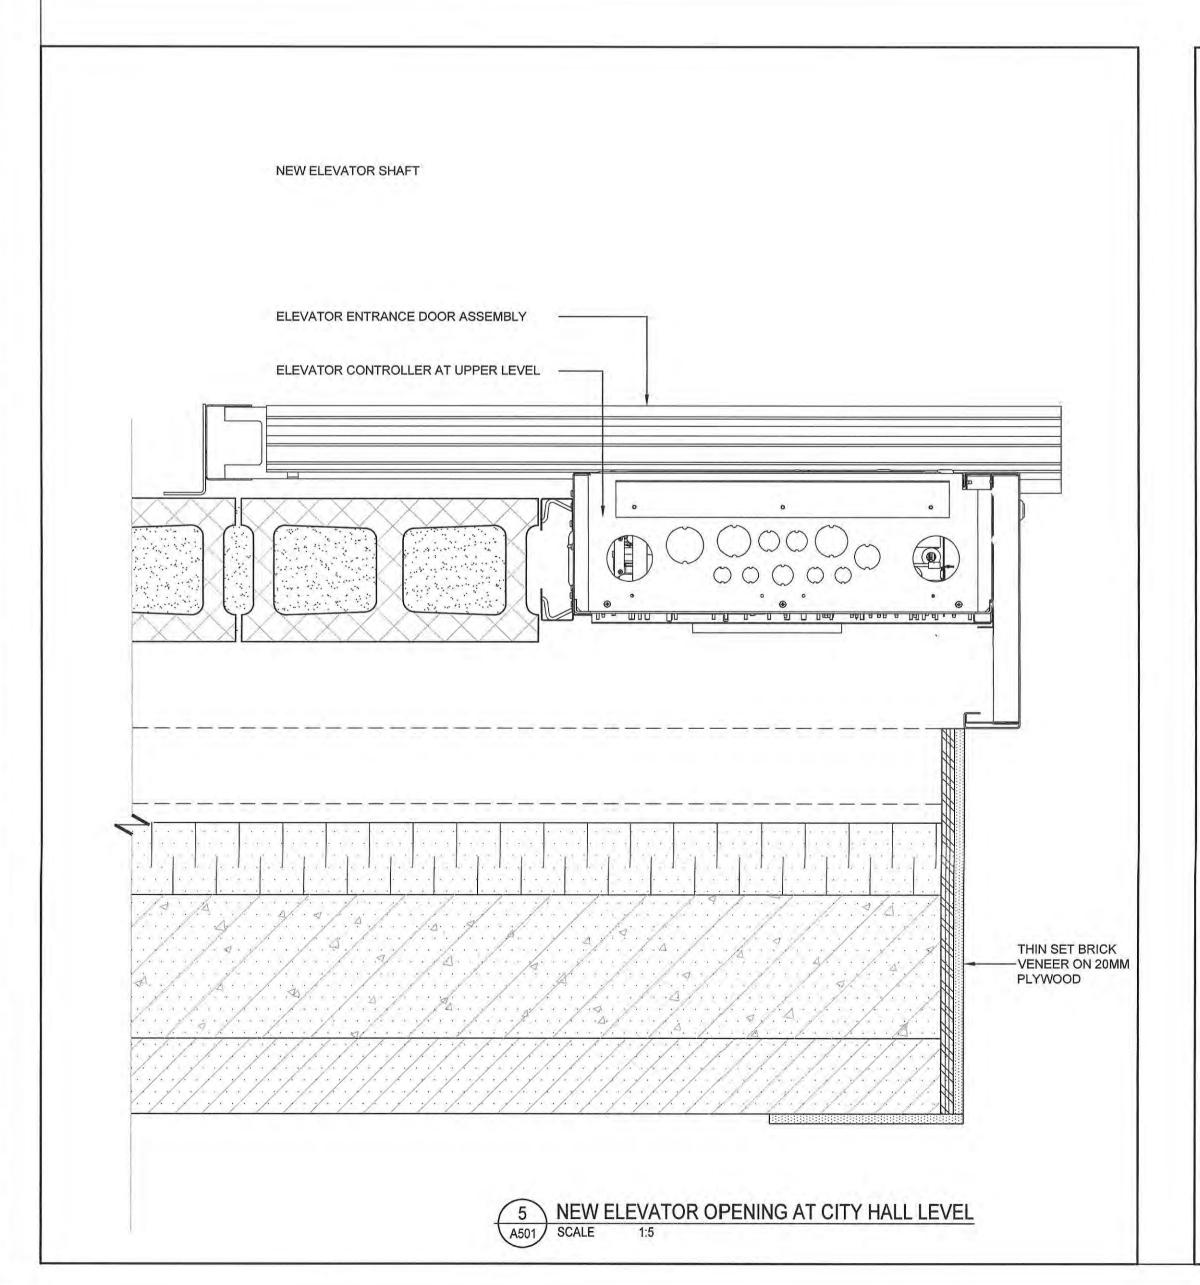
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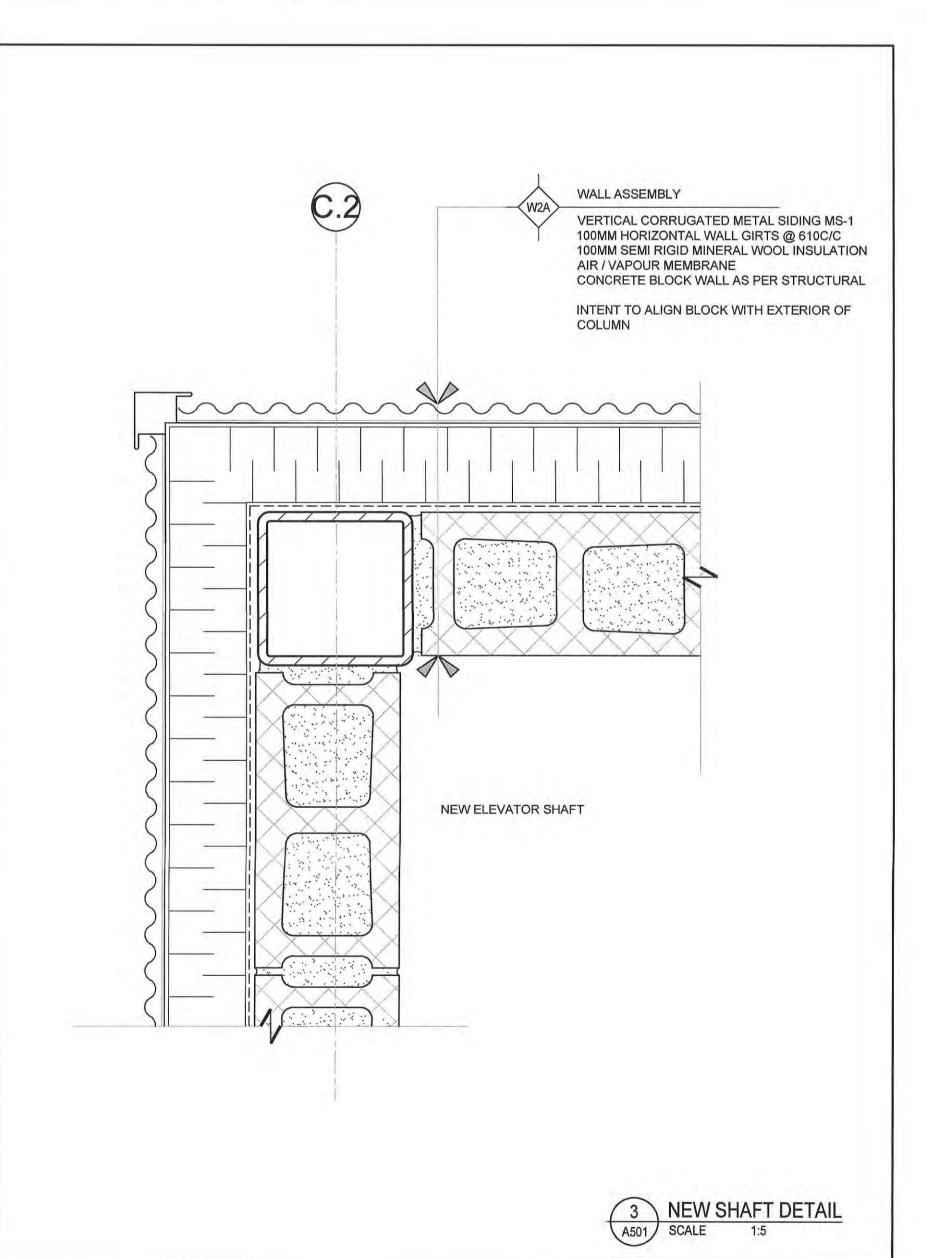


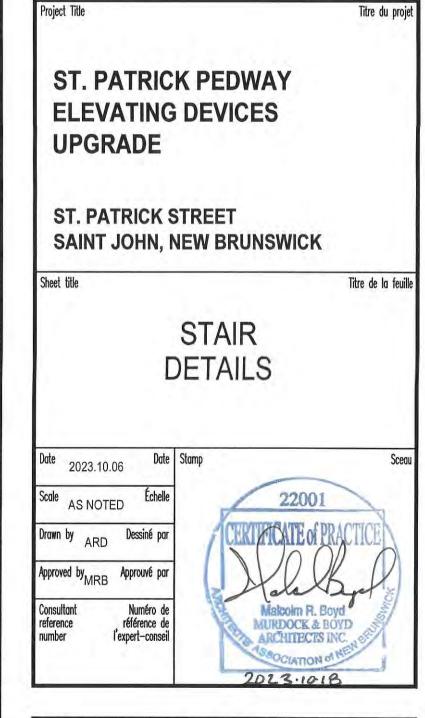
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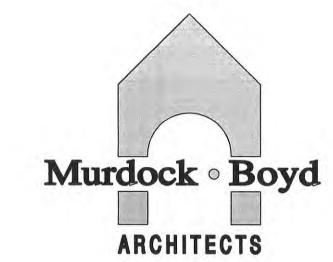




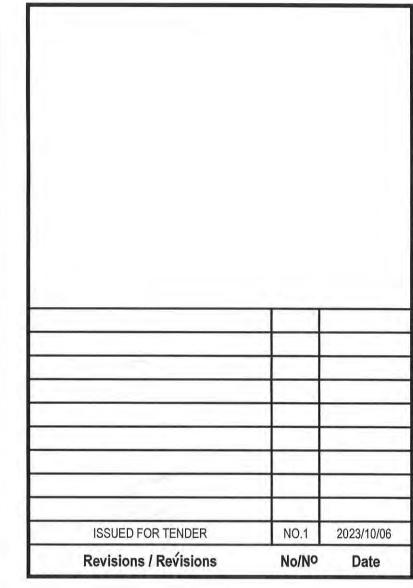






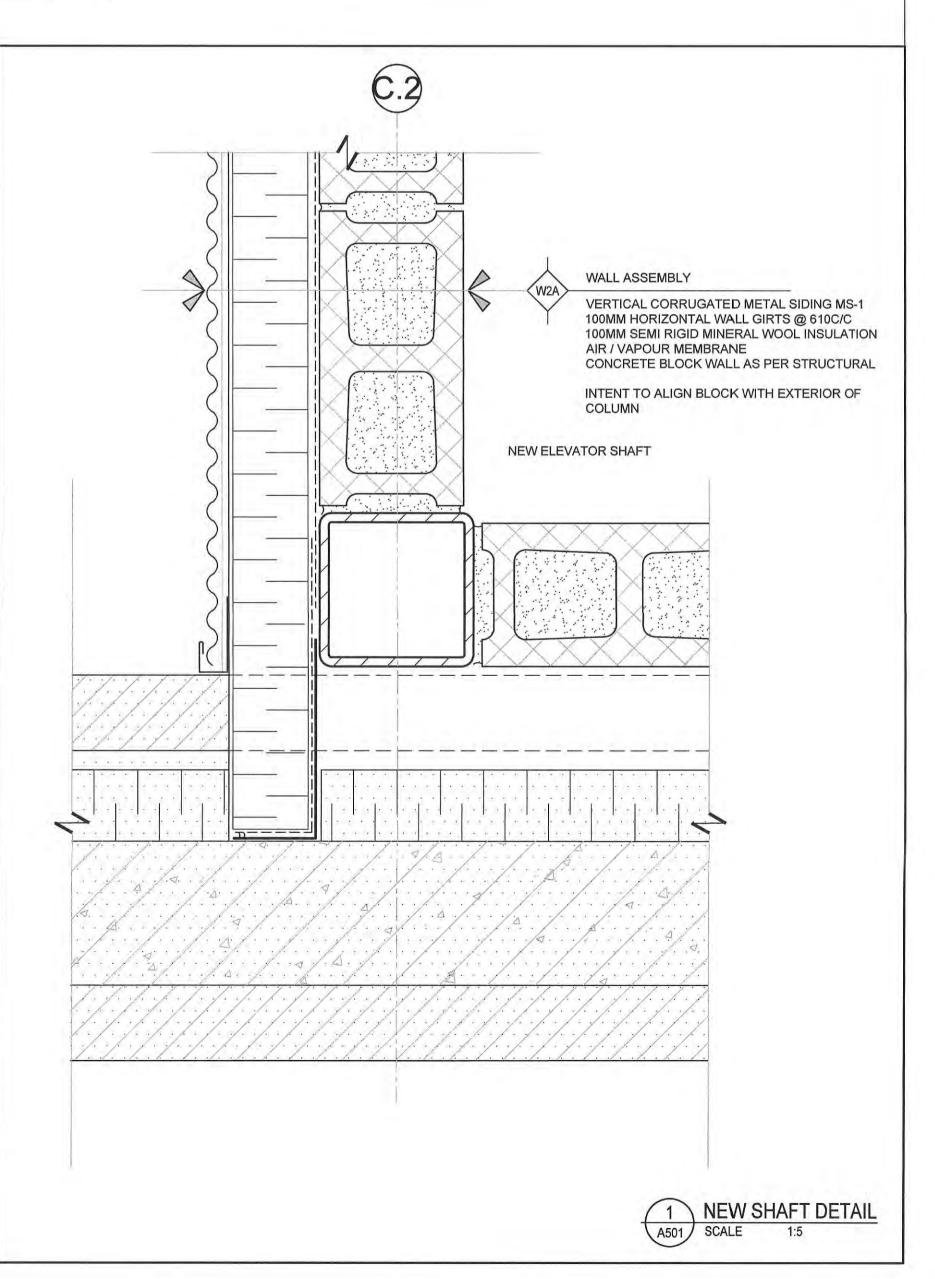

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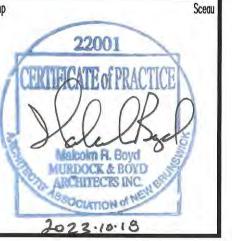
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Titre du projet ST. PATRICK STREET PEDWAY **RENOVATION AND ELEVATOR ADDITION** 

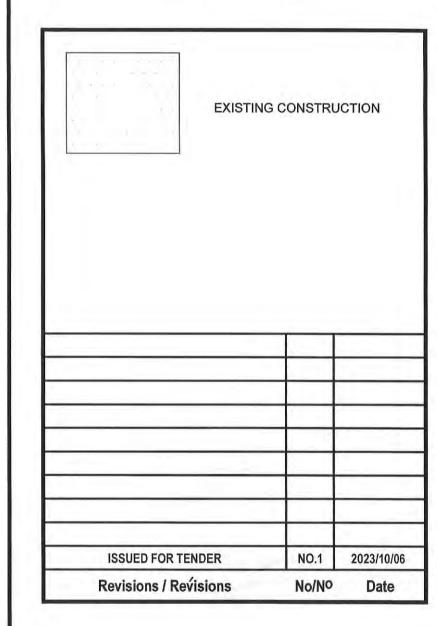ST. PATRICK STREET SAINT JOHN, NEW BRUNSWICK

PLAN **DETAILS** 

AS NOTED Approved by MRB Approuvé par Numéro de référence de l'expert-conseil




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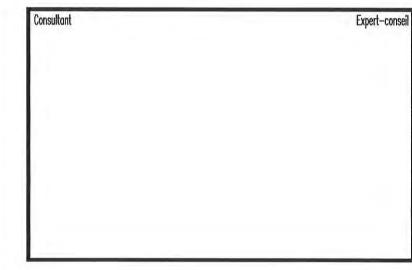
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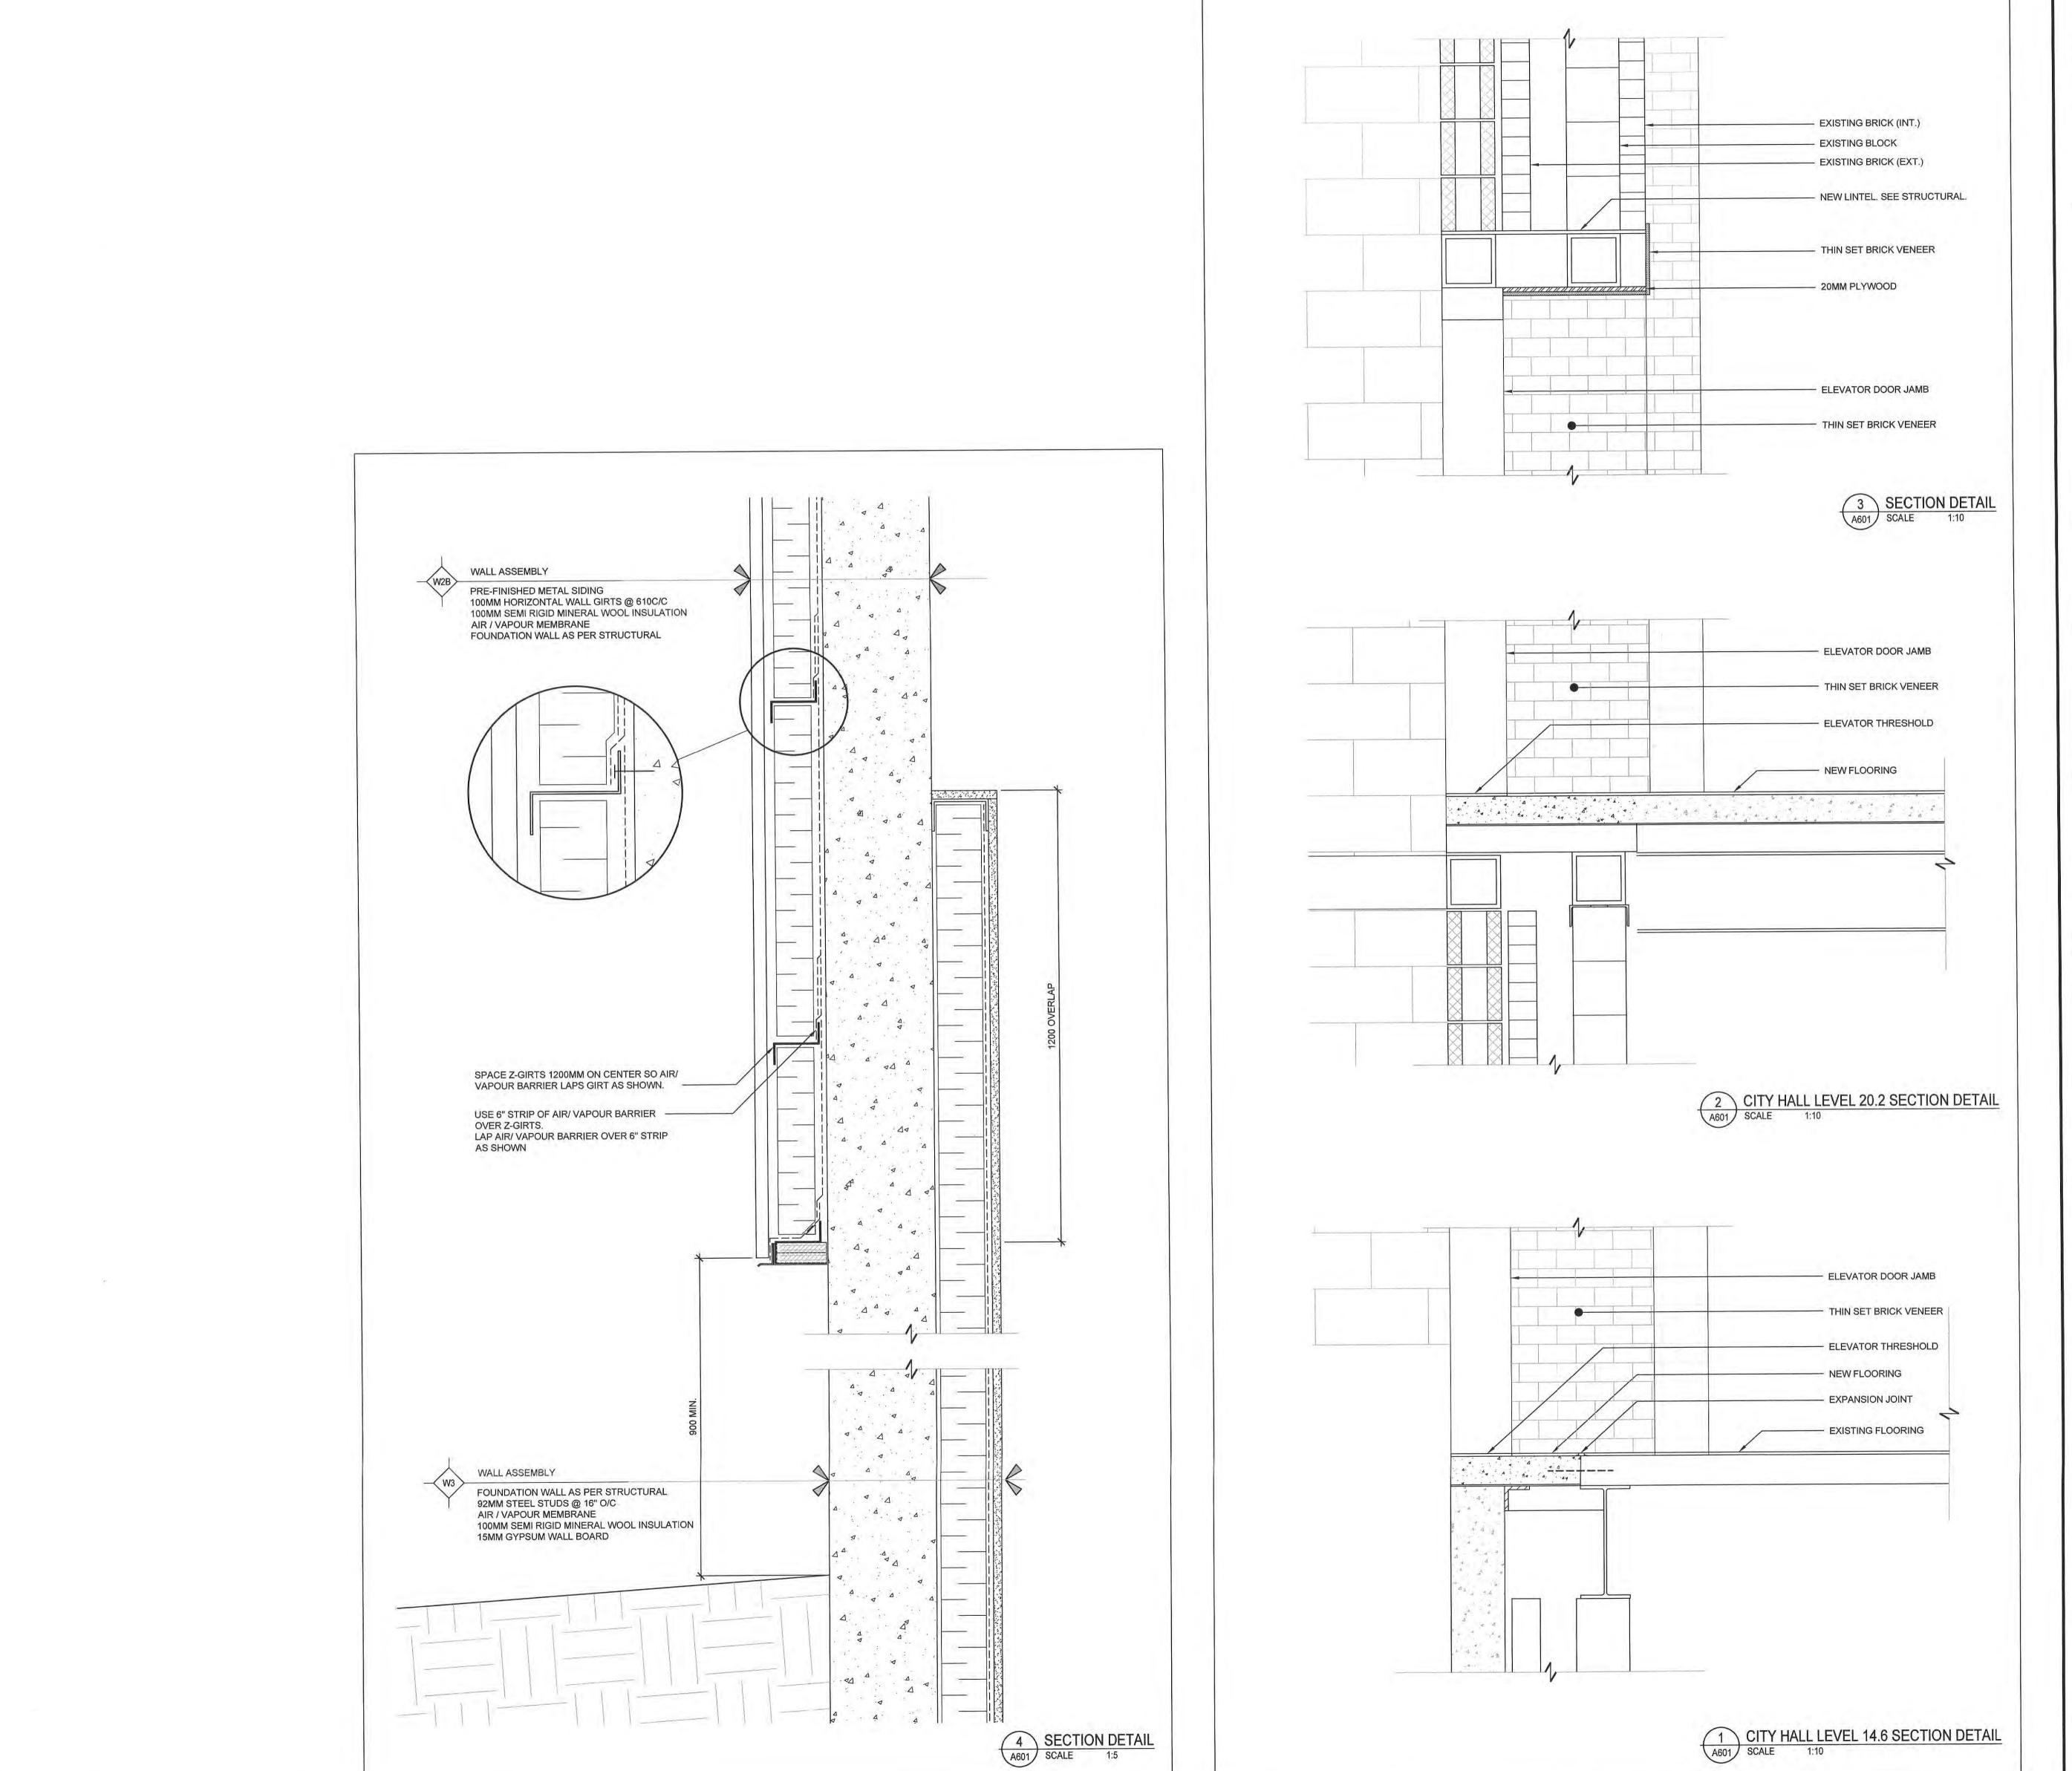


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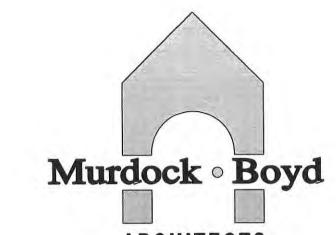


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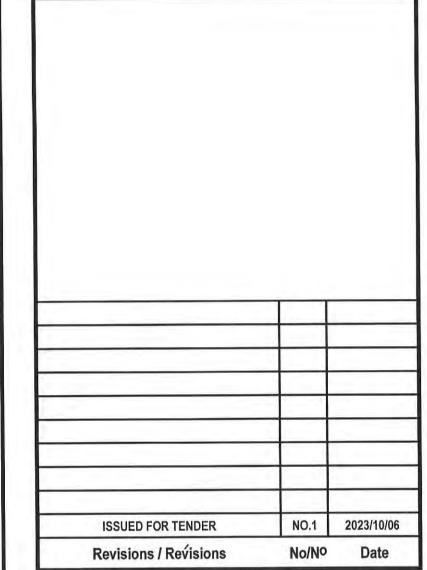


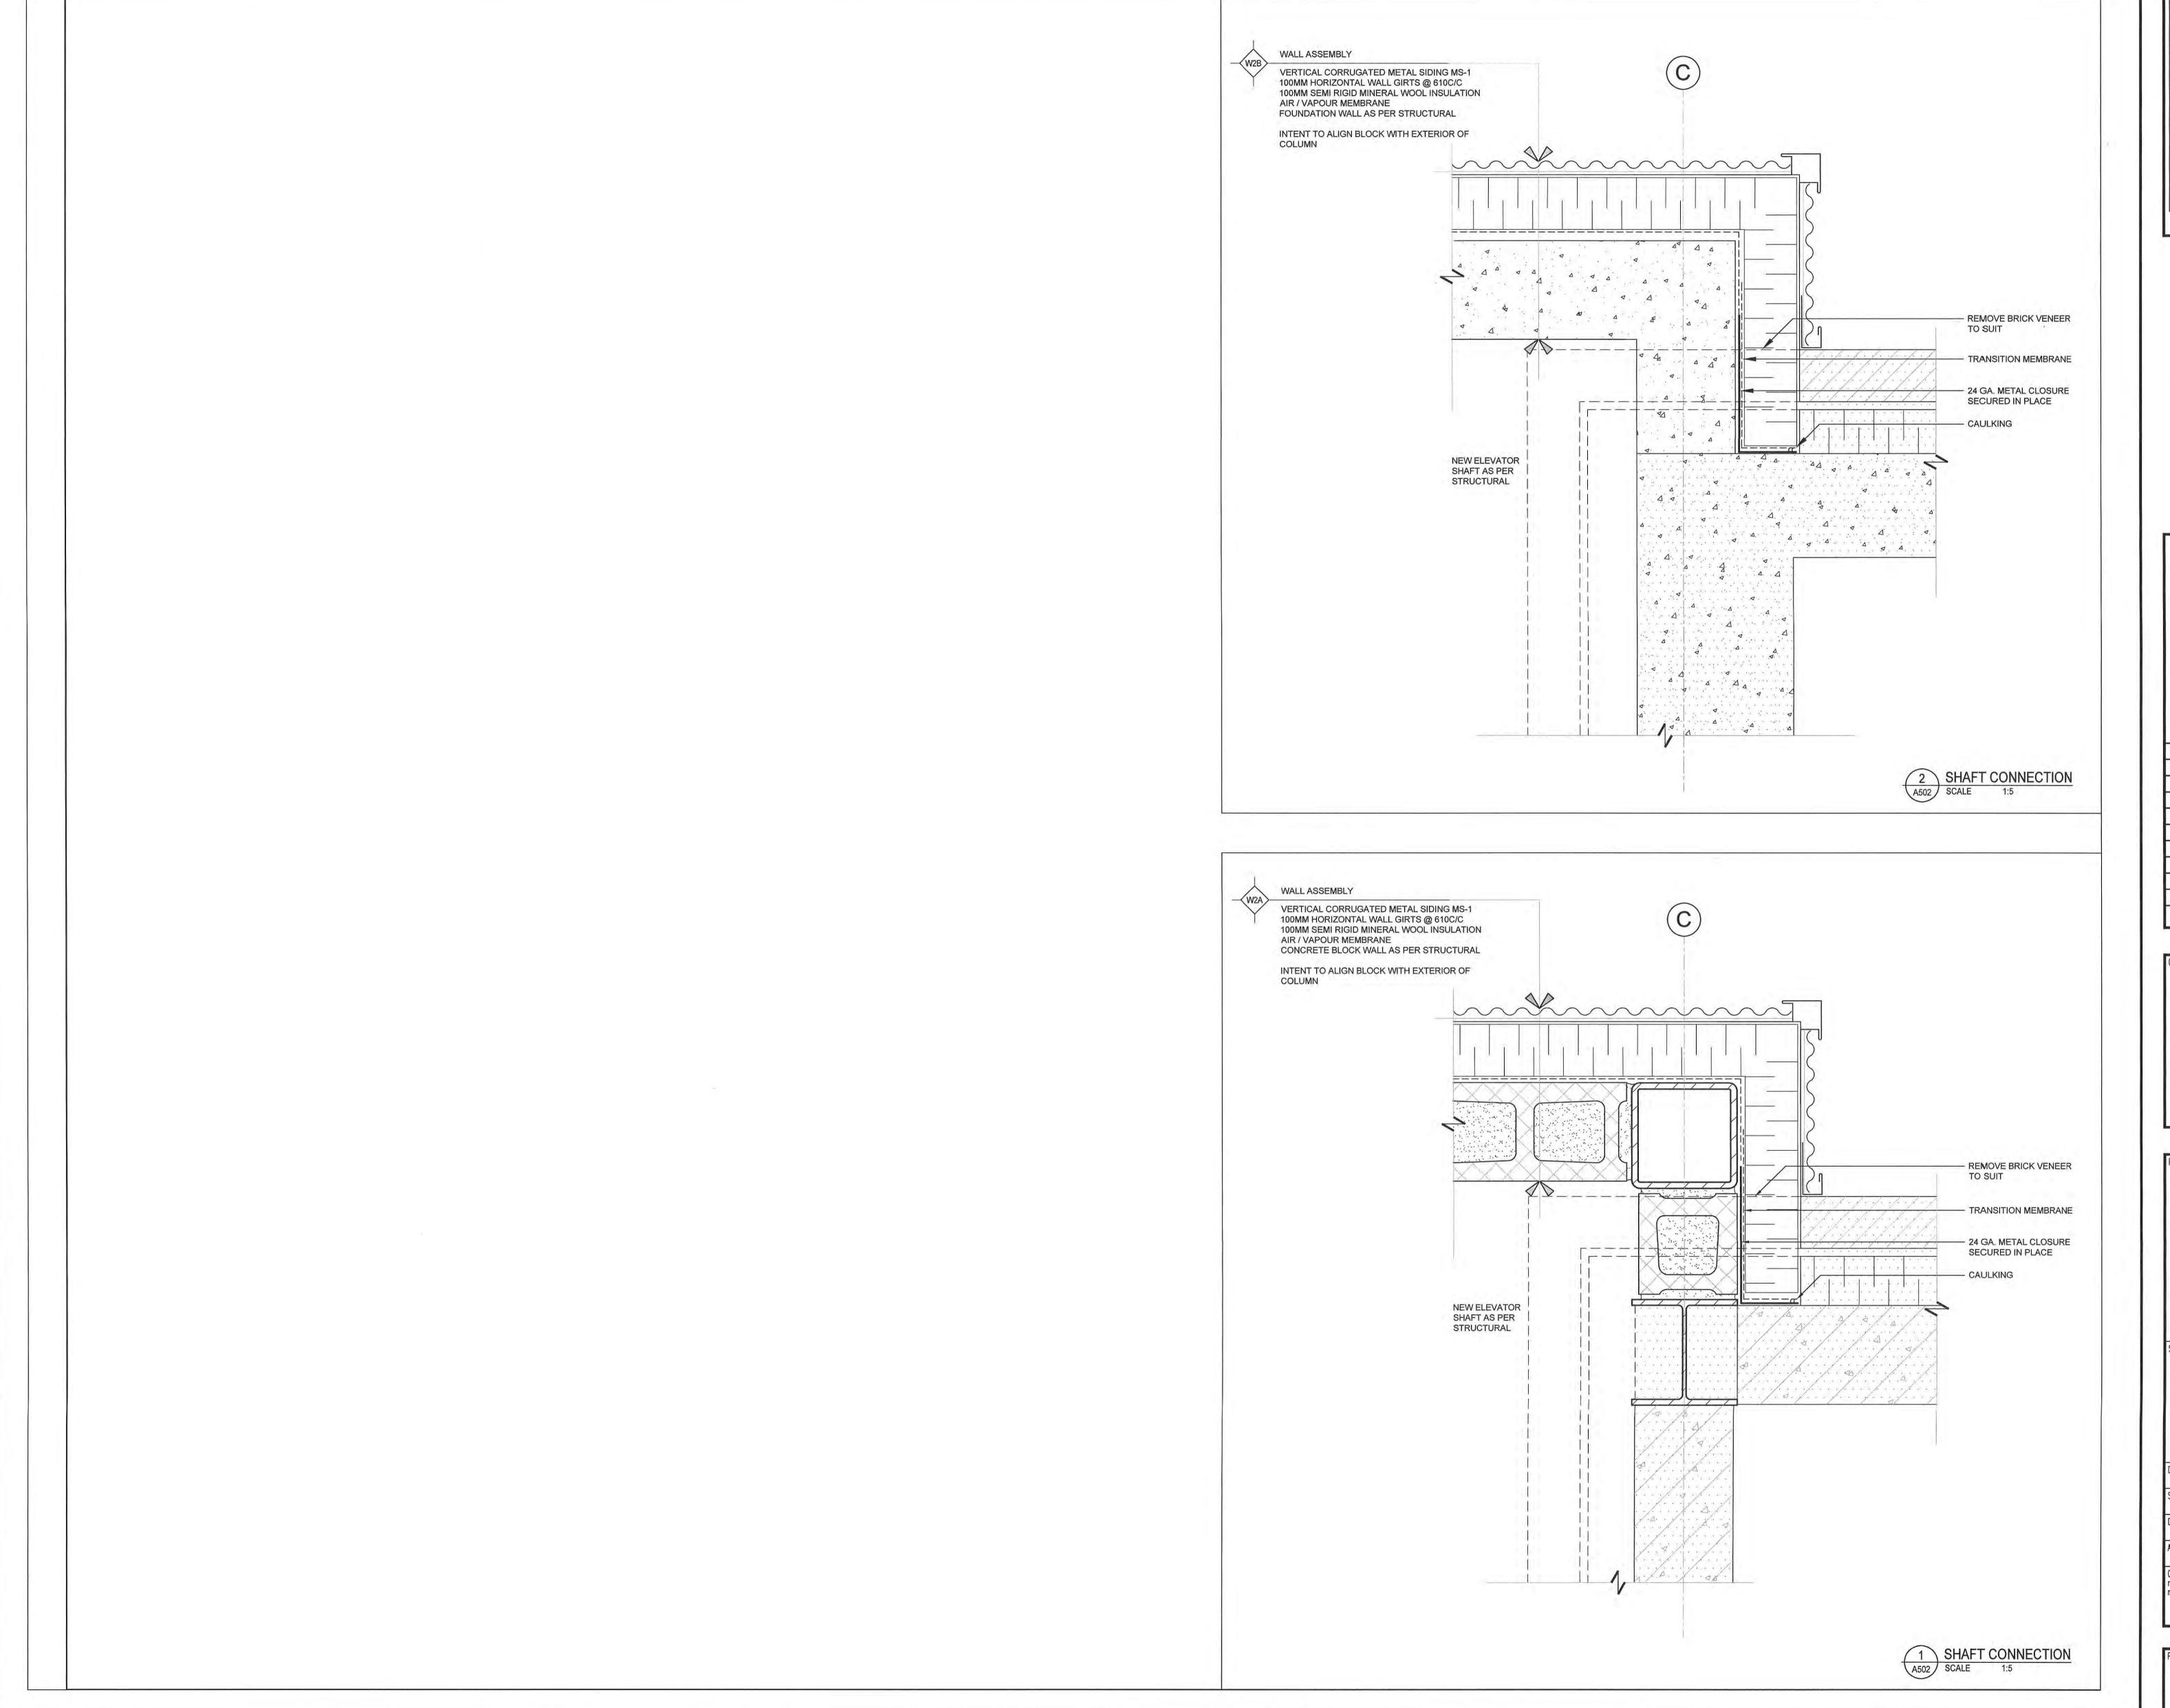


ARCHITECTS

50 KING STREET, SUITE 200
SAINT JOHN, NEW BRUNSWICK
CANADA, E2L 1G4
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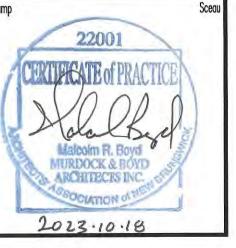
**ELEVATOR ADDITION** 

ST. PATRICK STREET SAINT JOHN, NEW BRUNSWICK

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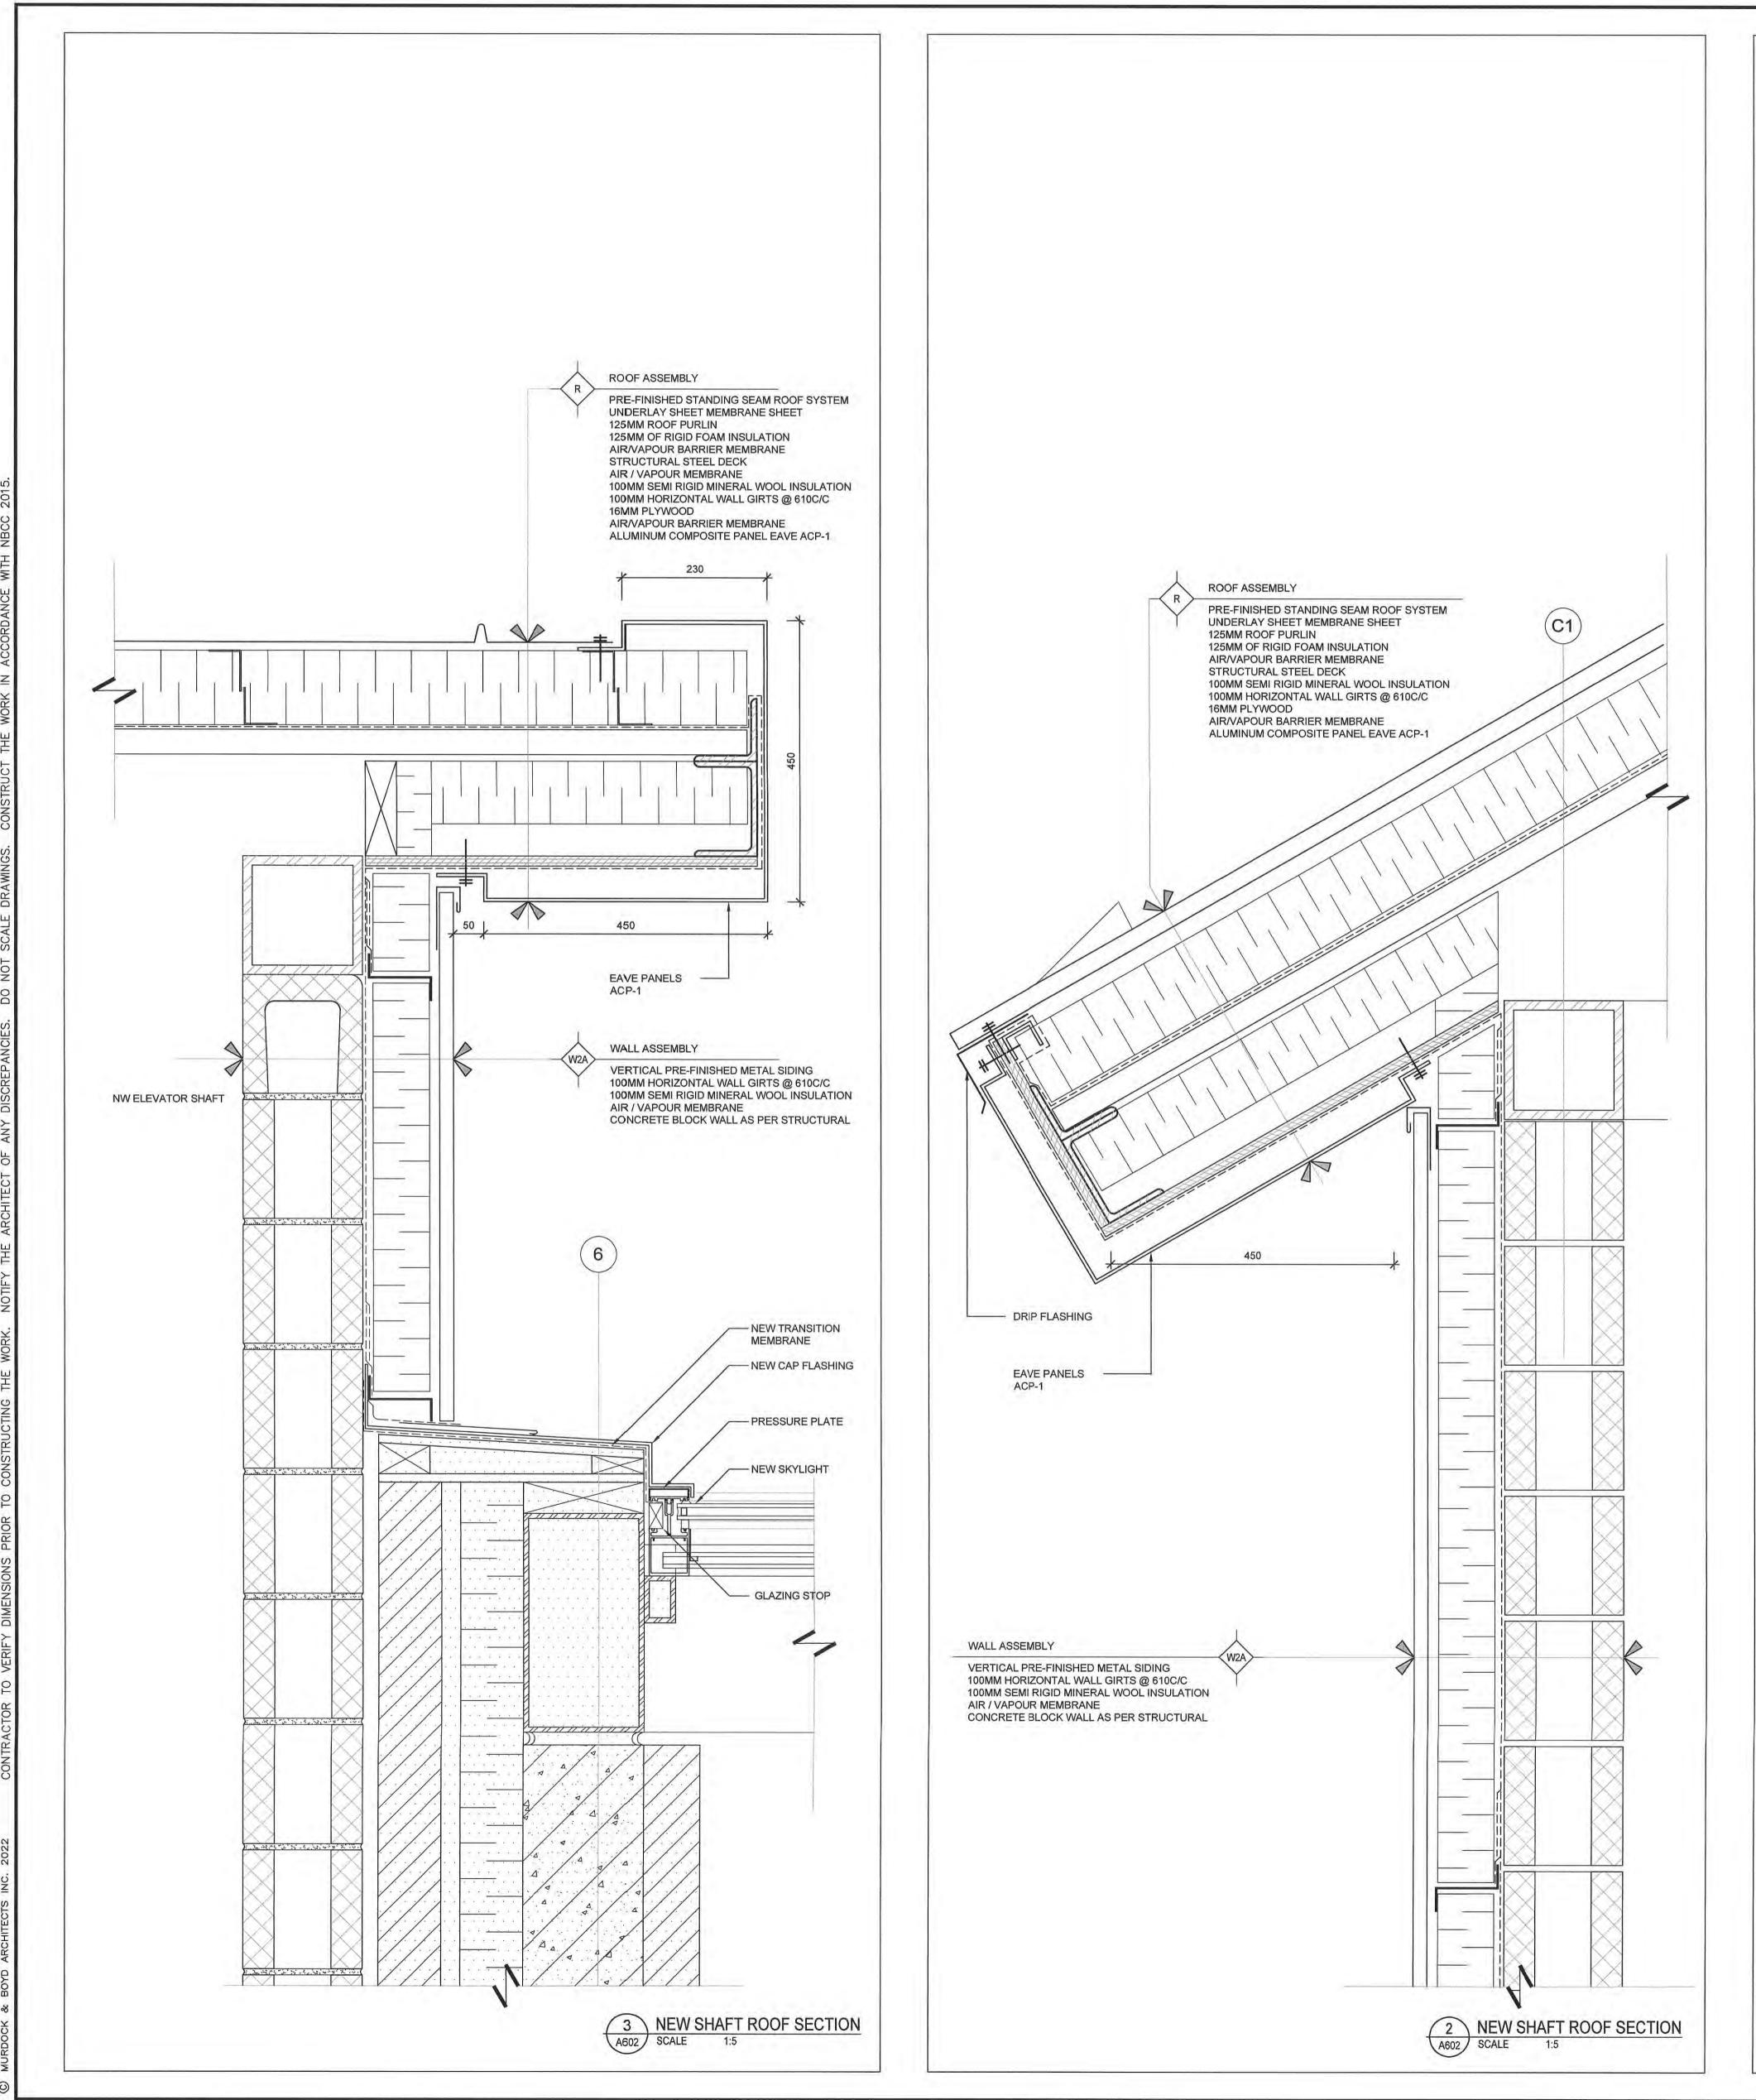


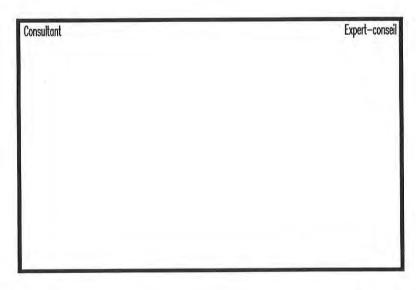
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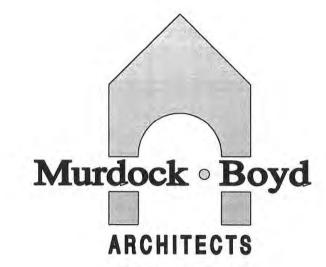
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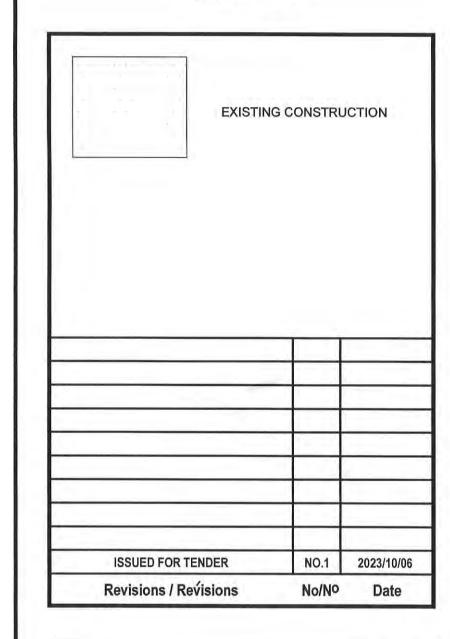






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ST. PATRICK STREET SAINT JOHN, NEW BRUNSWICK

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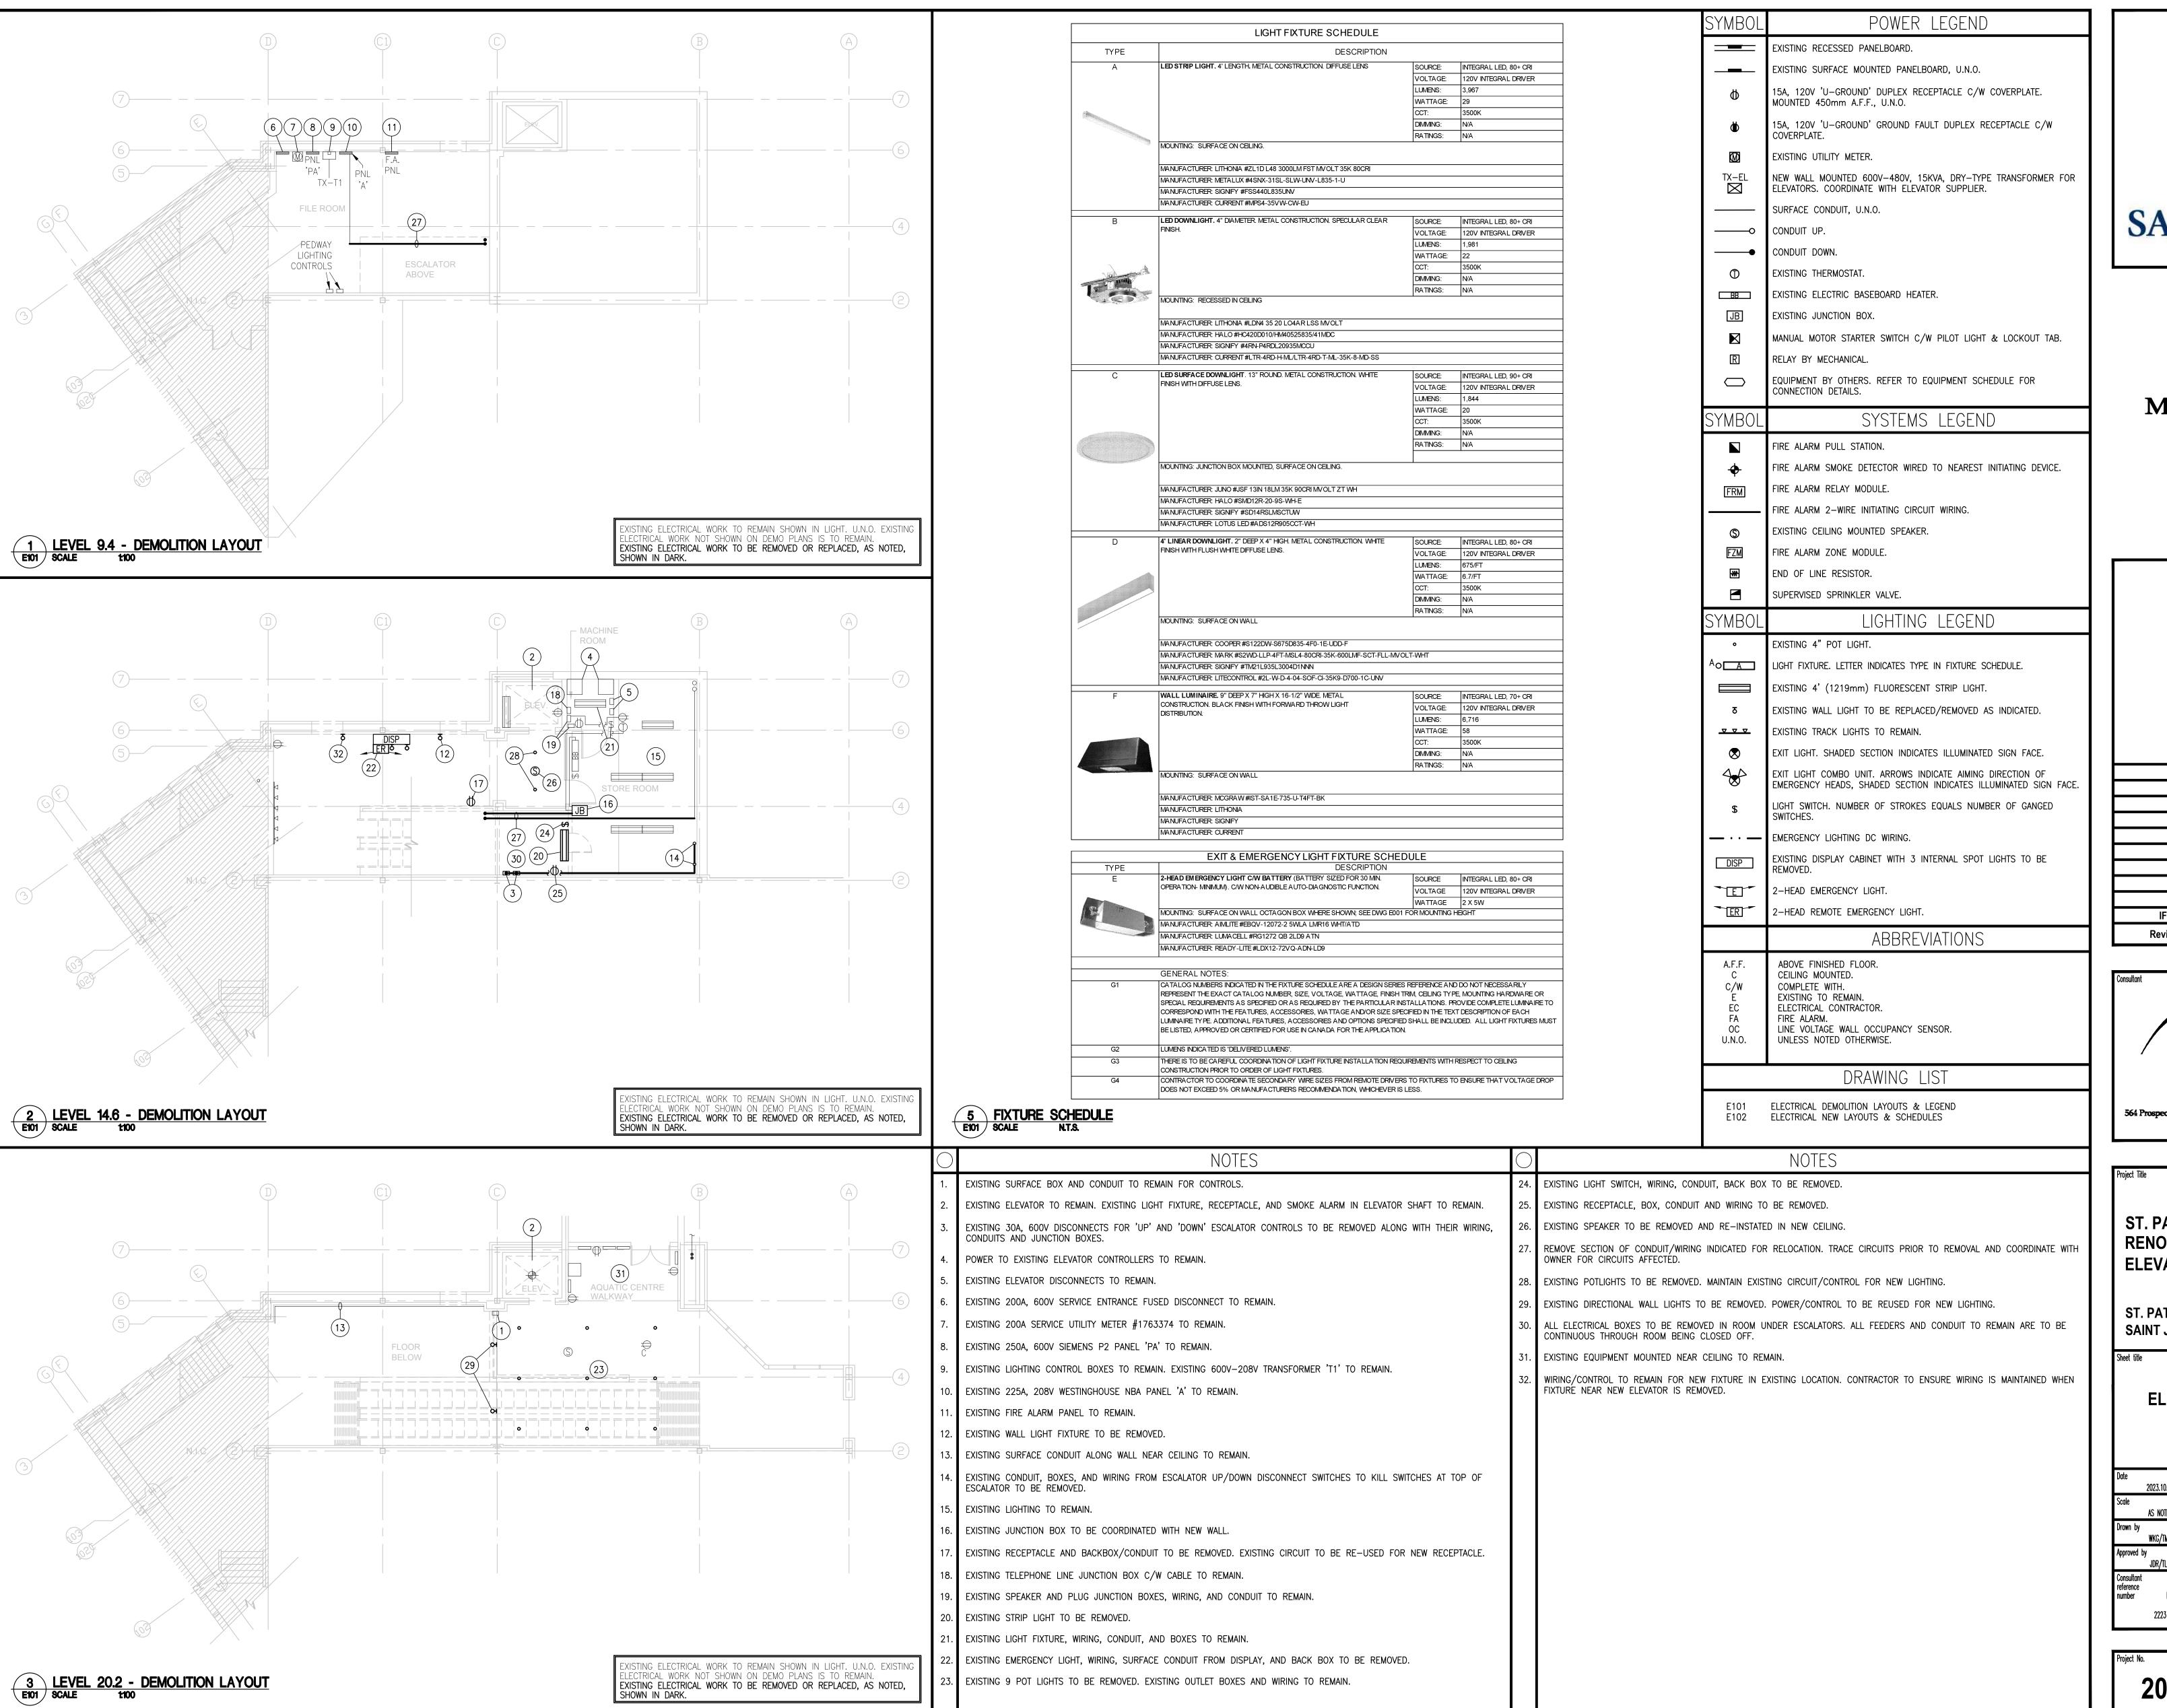
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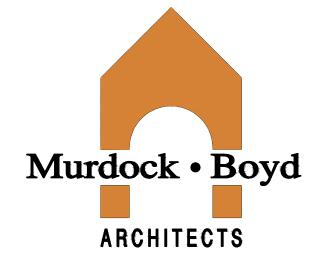
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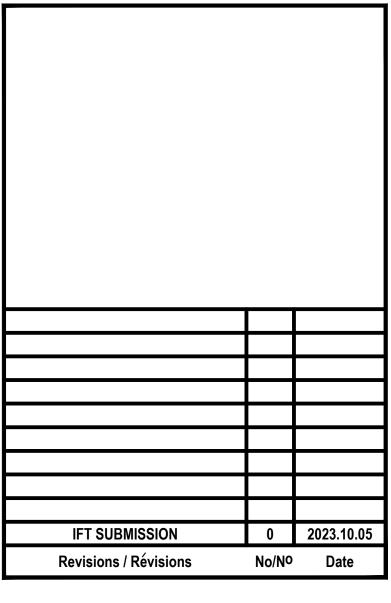


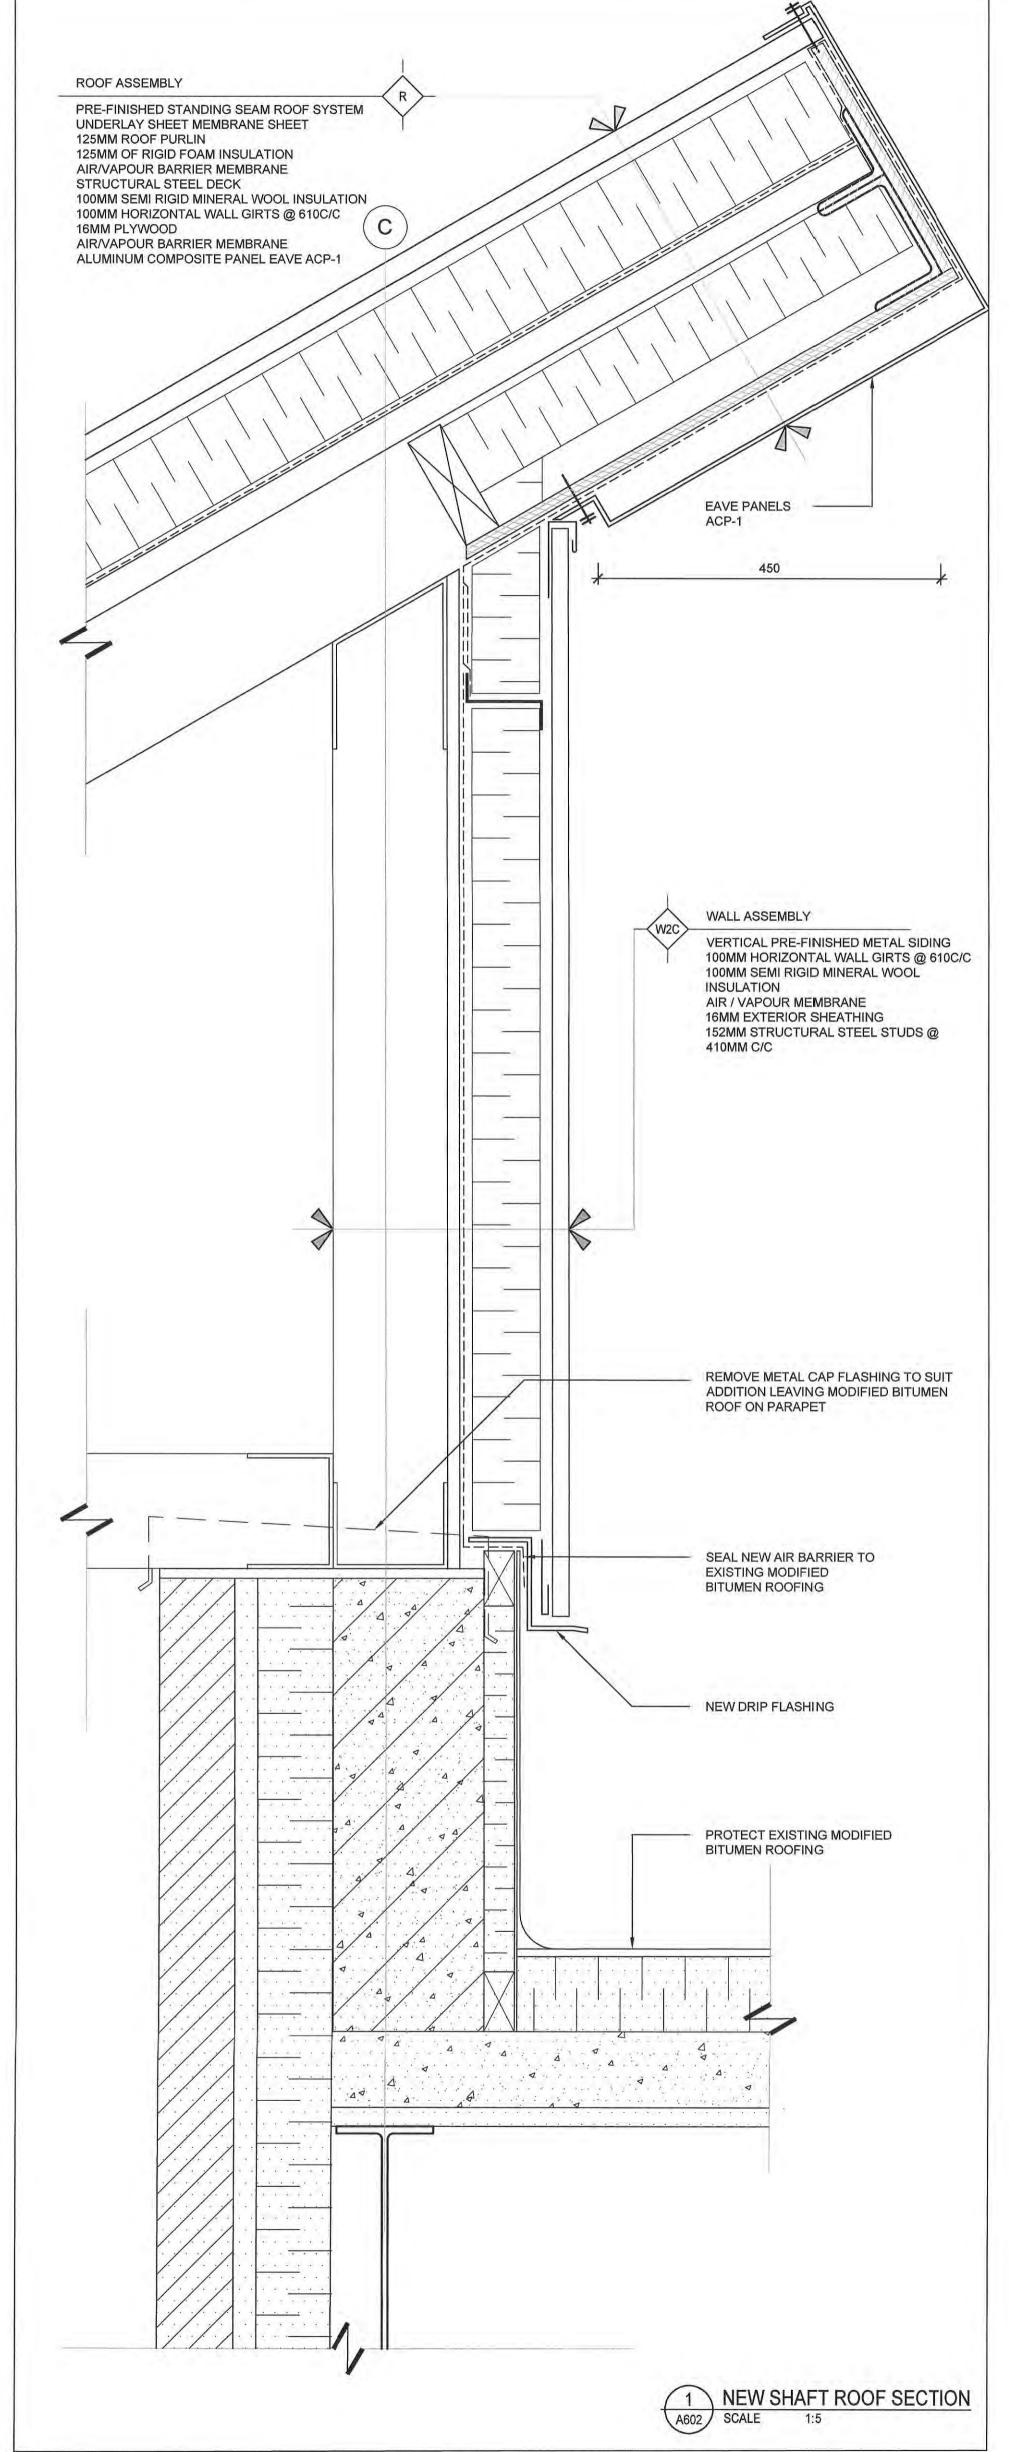



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ST. PATRICK STREET SAINT JOHN, NEW BRUNSWICK

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ELECTRICAL DEMOLITION LAYOUTS & LEGEND

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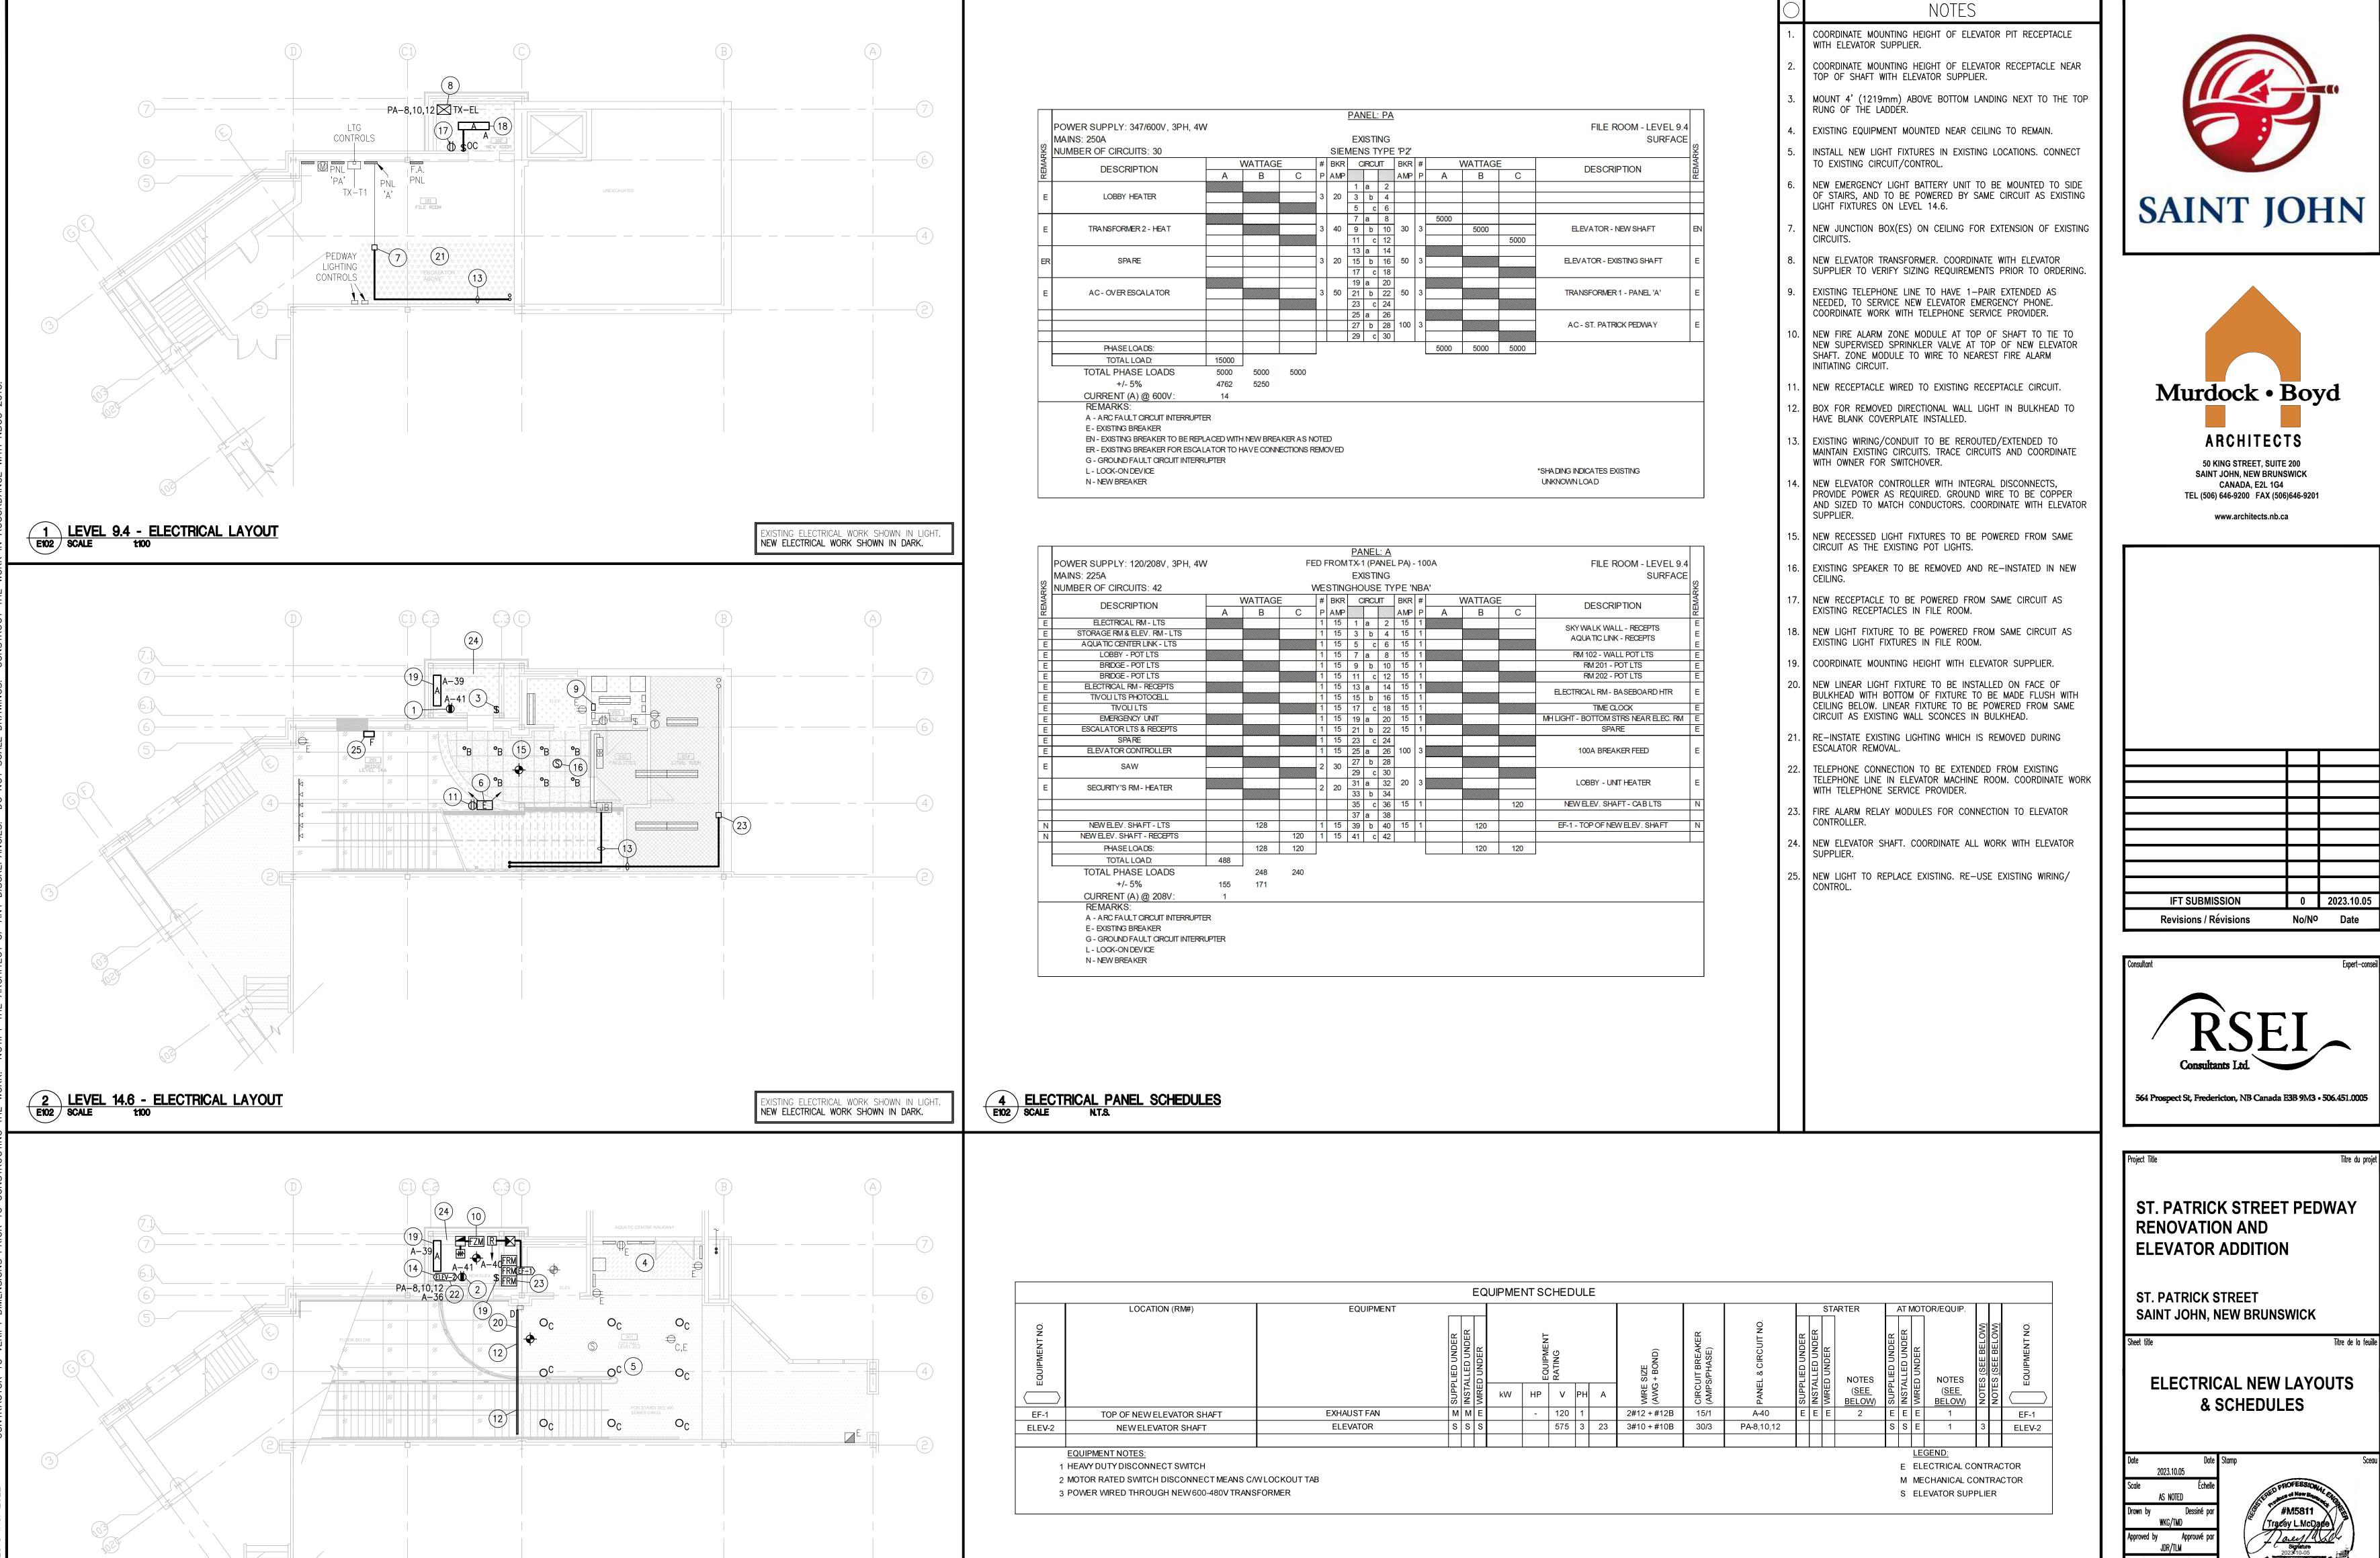
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5 EQUIPMENT SCHEDULE E102 SCALE NT.S.

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3 LEVEL 20.2 - ELECTRICAL LAYOUT E102 SCALE 1100




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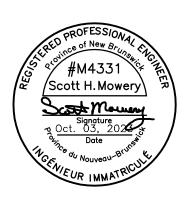
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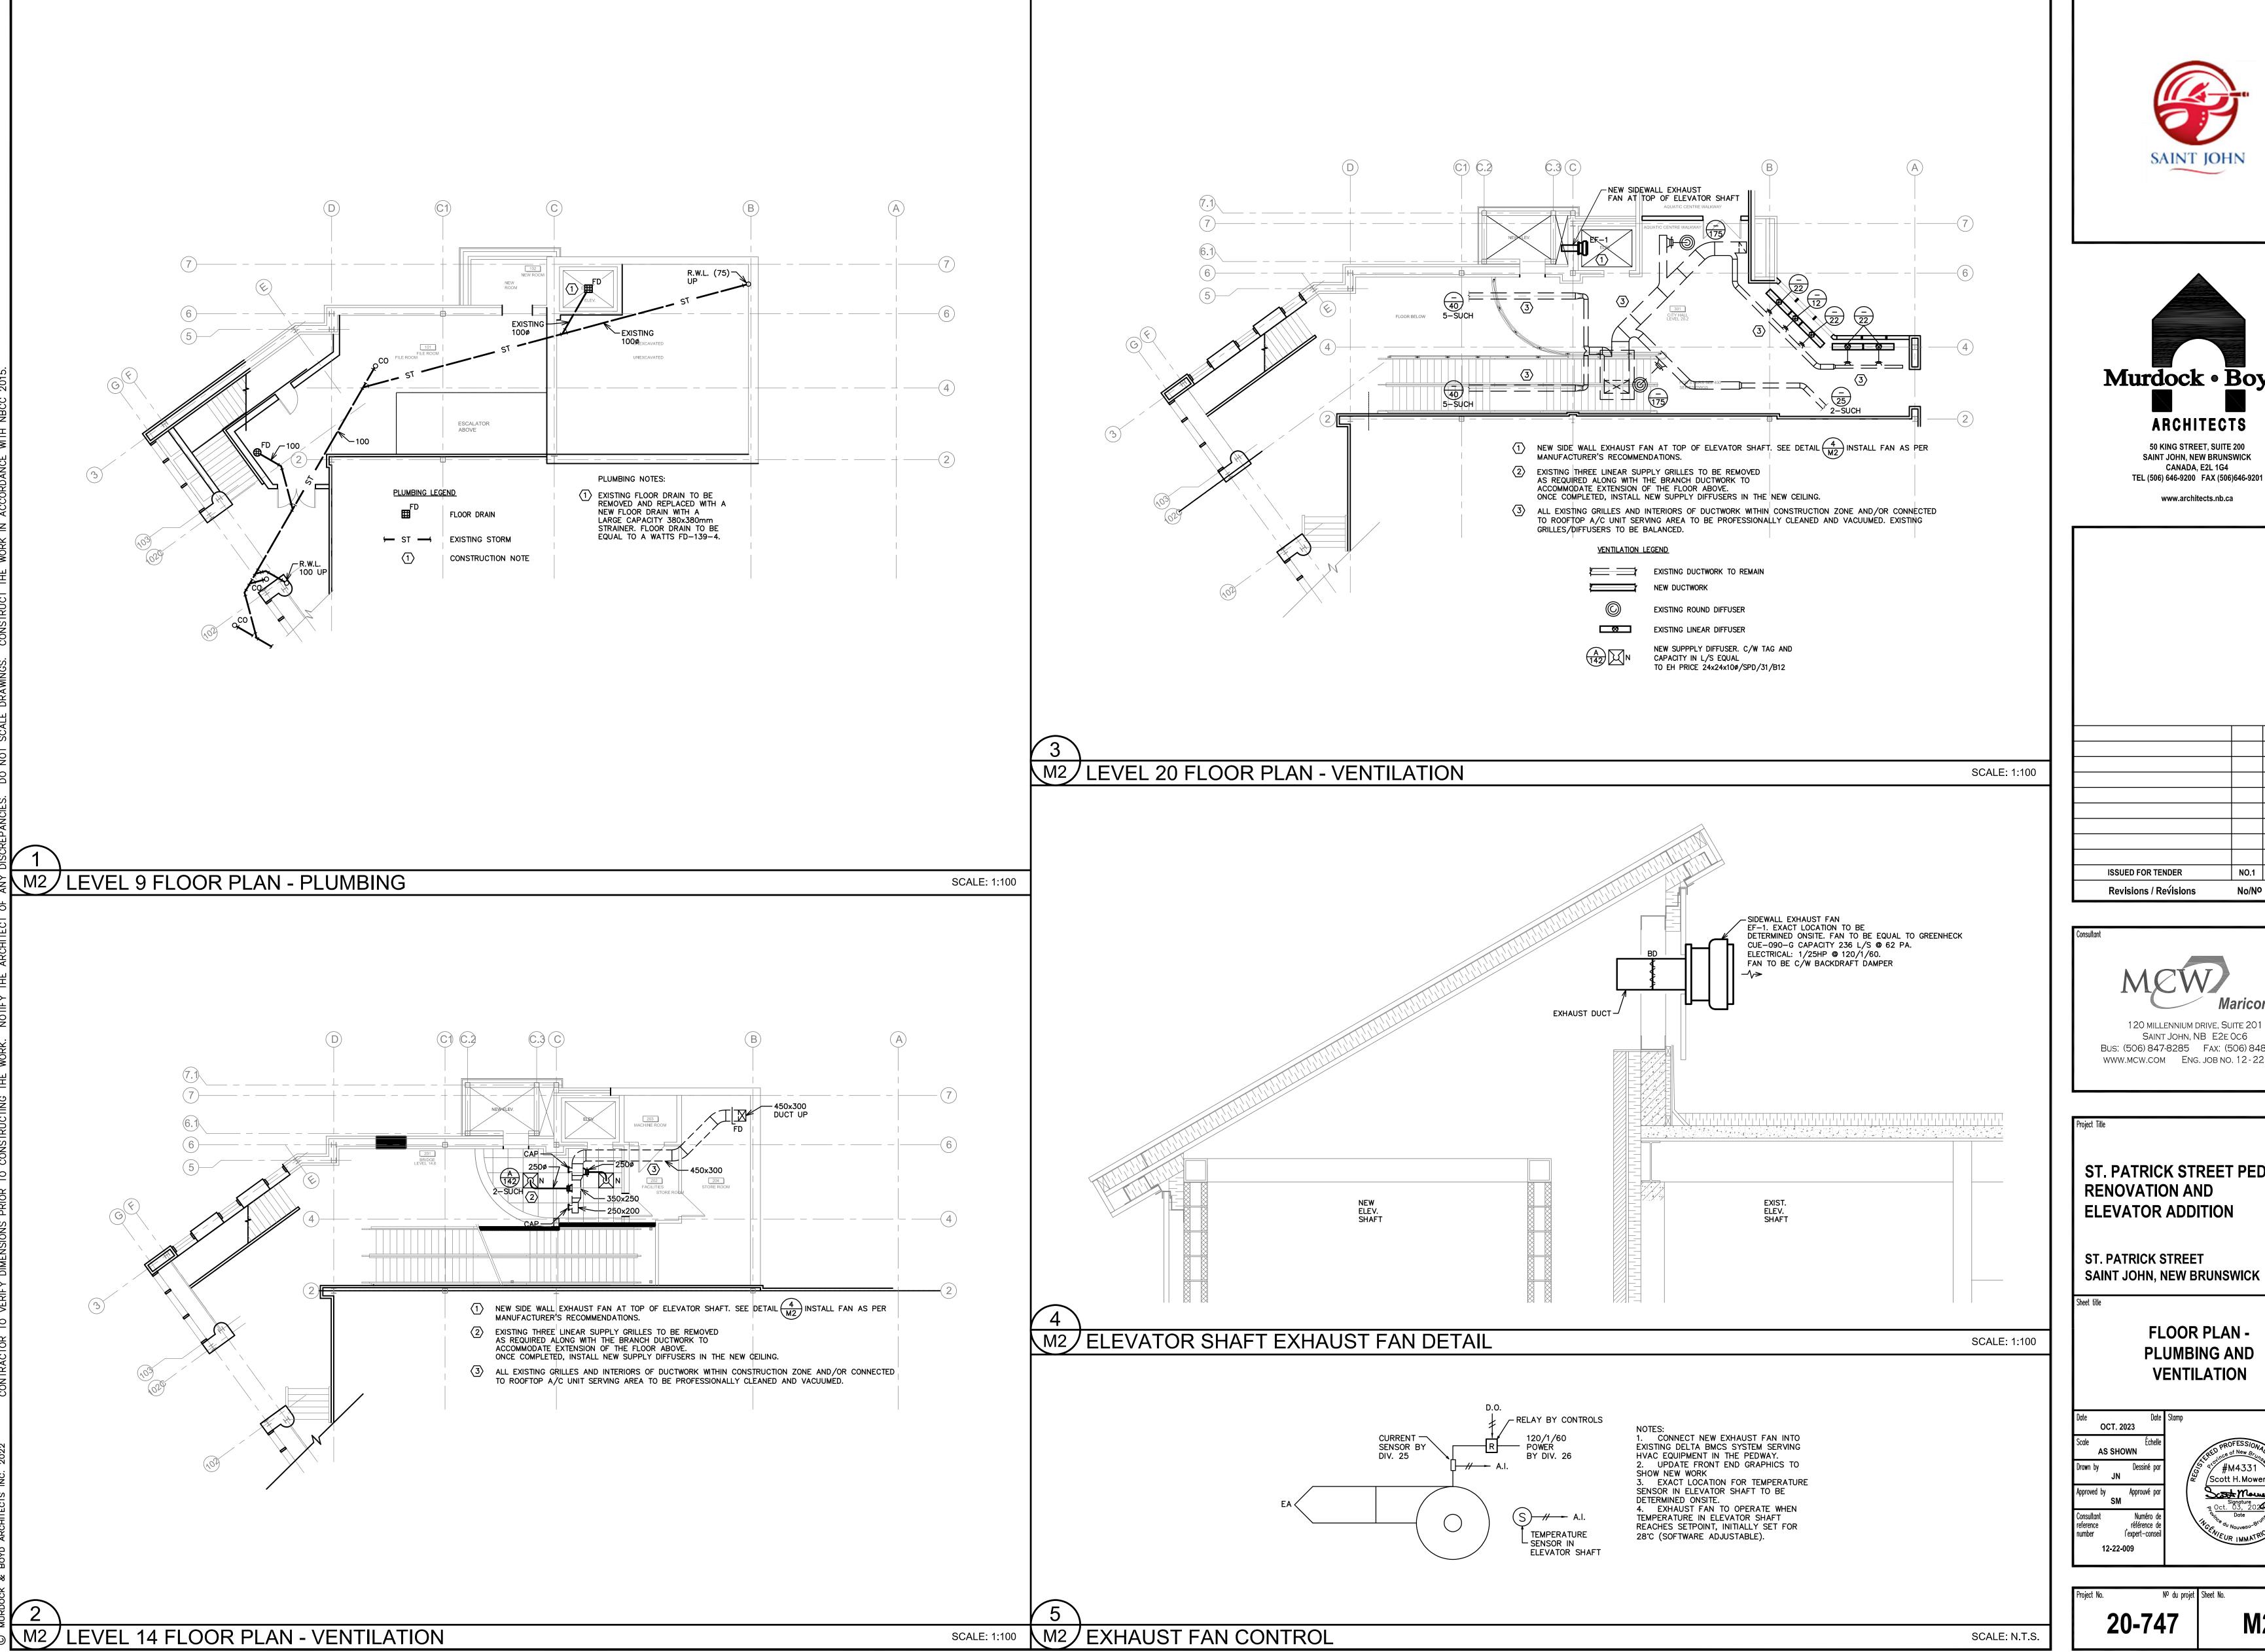
**FLOOR PLANS -**FIRE PROTECTION

OCT. 2023 AS SHOWN




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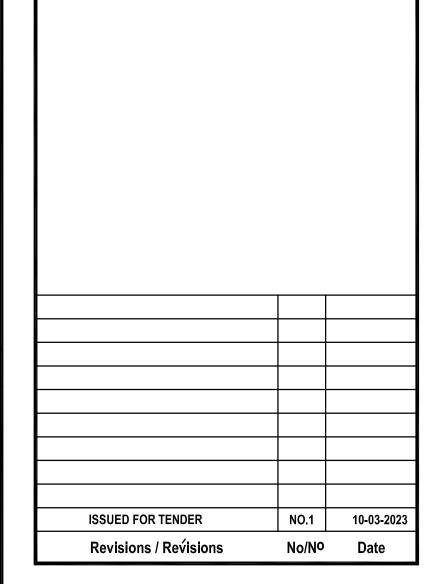
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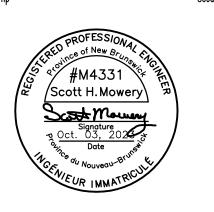
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ST. PATRICK STREET PEDWAY

**PLUMBING AND VENTILATION** 

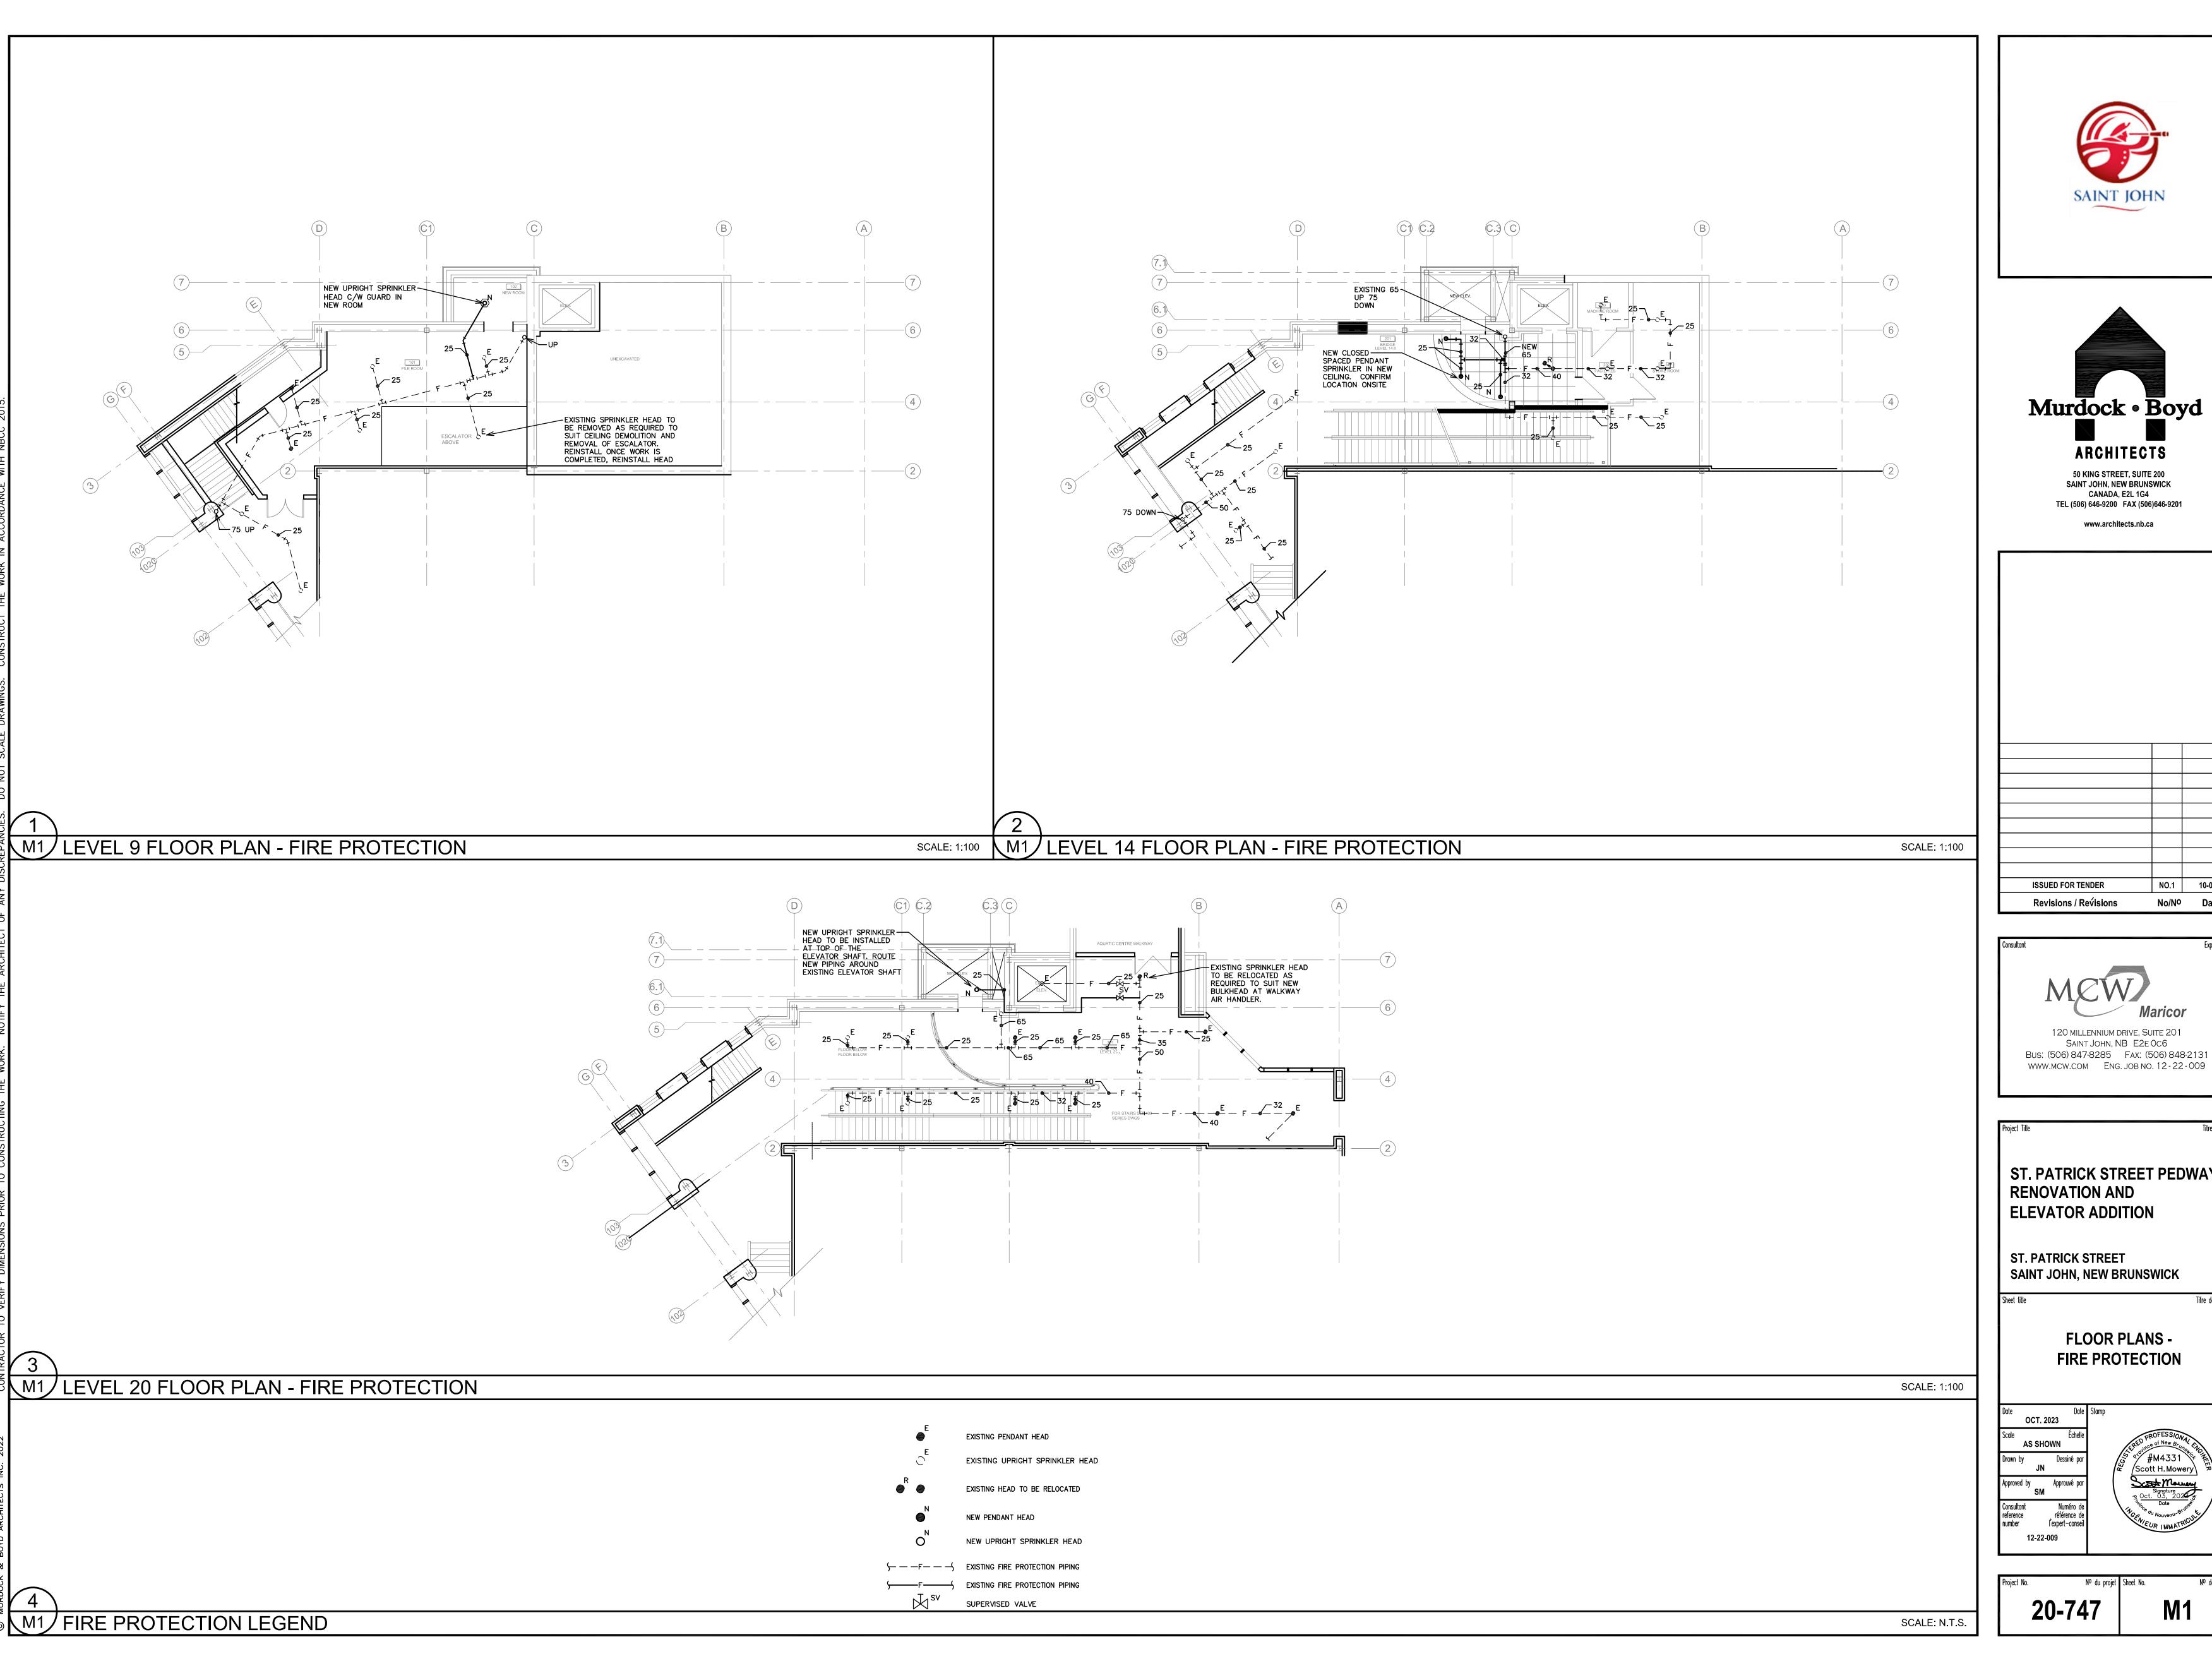


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ST. PATRICK STREET PEDWAY RENOVATION AND ELEVATOR ADDITION

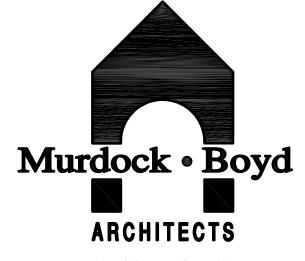ST. PATRICK STREET SAINT JOHN, NEW BRUNSWICK

Sheet title

MECHANICAL SPECIFICATIONS

Date OCT. 2023
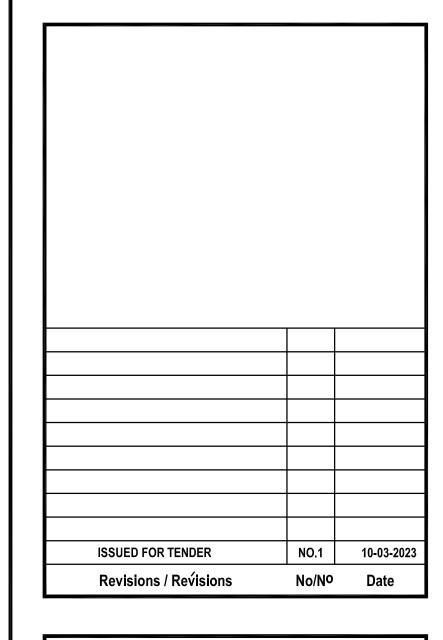
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Drawn by Dessiné par JN

Approved by Approuvé par

Scott H. Mowery

Signature

Oct. 03, 2022

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#### MECHANICAL GENERAL CONDITIONS

- .1 GENERAL
  THE FOLLOWING GENERAL CONDITIONS SHALL BE READ IN CONJUNCTION WITH THE ENTIRE CONTRACT
- .2 SCOPE OF WORK

  THE CONTRACTOR SHALL INCLUDE ALL LABOR, MATERIALS, EQUIPMENT AND ASSOCIATED SERVICES NECESSARY FOR, AND REQUIRED BY THE INSTALLATION OF COMPLETELY FINISHED, TESTED, BALANCED AND PROPERLY OPERATING MECHANICAL SYSTEMS AS SPECIFIED HEREAFTER AND SHOWN ON THE DRAWINGS. THE INTENTION IS TO PROVIDE FOR FINISHED WORK COMPLETE IN ALL ESSENTIALS AS CALLED FOR BY THE DOCUMENTS AND ACCEPTED GOOD PRACTICE.
- THE WORK SHALL INCLUDE THE FOLLOWING:
- VENTILATION:
  INSTALL NEW EXHAUST FAN, REMOVE AND REINSTALL EXISTING AND OR NEW DIFFUSERS AND DUCTWORK
  AS INDICATED. PROVIDE BALANCING. HVAC CONTRACTOR TO BE RESPONSIBLE FOR BMCS WORK.
- .2 SPRINKLER:
  INSTALL NEW SPRINKLER HEADS AS INDICATED.
- .3 PLUMBING:
  REMOVED EXISTING ELEVATOR FLOOR DRAIN AND INSTALL NEW DRAIN.

#### .3 PERMITS AND BY-LAWS

- THE CONTRACTOR SHALL ABIDE BY ALL CODES AND BY—LAWS RELATING TO THIS INSTALLATION. PROVIDE NECESSARY NOTICES, OBTAIN PERMITS AND PAY ALL FEES, IN ORDER THAT WORK SPECIFIED MAY BE CARRIED OUT. CHANGES AND ALTERATIONS REQUIRED BY AUTHORIZED INSPECTOR OF ANY AUTHORITY HAVING JURISDICTION, TO BE CARRIED OUT WITHOUT CHARGE OR EXPENSE TO OWNER.
- .4 SITE VISIT

  BEFORE TENDERING THE CONTRACTOR SHALL VISIT THE SITE AND FAMILIARIZE THEMSELVES WITH THE EXISTING CONDITIONS AT THE SITE WHERE THE WORK HAS TO BE DONE. NO EXTRA WILL BE ALLOWED DUE TO FAILURE TO TAKE SITE CONDITIONS INTO CONSIDERATION.
- .5 COORDINATION OF WORK
  THIS CONTRACTOR SHALL COORDINATE THEIR WORK WITH THE OWNER AND WITH ALL OTHER
  SUB-CONTRACTORS. COOPERATE WITH THE OWNER AND OTHER CONTRACTORS. WORK SHALL BE EXECUTED IN
  A MANNER SO AS TO CAUSE MINIMUM DISRUPTION. ALL SERVICES INTERRUPTIONS SHALL BE SCHEDULED. THIS
  CONTRACTOR SHALL INCLUDE IN THEIR TENDER, COSTS FOR ALL OVERTIME WORK INVOLVED WITH THE
  CONSTRUCTION.
- .6 GUARANTEE
  THE CONTRACTOR SHALL GUARANTEE ALL WORK AND NEW EQUIPMENT INSTALLED UNDER THIS SPECIFICATION AGAINST ANY DEFECTS OF WORKMANSHIP AND MATERIAL FOR A PERIOD OF ONE YEAR AFTER ACCEPTANCE OF SAME BY OWNER. REPAIR AND MAKE GOOD ALL DAMAGE TO BUILDING INCURRED AS A RESULT OF FAILUR OF MECHANICAL WORK. PROVIDE FREE SERVICE AND MAINTENANCE OF ALL EQUIPMENT INCLUDING REPLACEMENT OF DISPOSABLE FILTERS FOR ONE FULL YEAR AFTER ACCEPTANCE OF THE SYSTEM.

#### .7 DRAWINGS

DRAWINGS.

- THE DRAWINGS FOR THE WORK ACCOMPANYING THESE SPECIFICATIONS ARE MADE AS ACCURATELY AS POSSIBLE, BUT ABSOLUTE ACCURACY OF DIMENSIONS CANNOT BE GUARANTEED. THEY ARE INTENDED TO SUPPLEMENT AND SIMPLIFY THE GENERAL CONTRACT DRAWINGS. NO CLAIM FOR EXTRA PAYMENT ON ACCOUNT OF DIFFERENCE OF ACTUAL AND ESTIMATED DIMENSIONS SHALL BE ALLOWED. IN THE CASE OF DISCREPANCY OF FIGURE DIMENSIONS ON THE DRAWINGS, THE MATTER SHALL BE IMMEDIATELY SUBMITTED TO THE OWNER FOR THEIR DECISION. WITHOUT THE DECISION, THE DISCREPANCY SHALL NOT BE ADJUSTED BY THE CONTRACTOR SAVE AT THEIR OWN RISK, AND IN THE SETTLEMENT OF ANY COMPLICATIONS ARISING FROM SUCH ADJUSTING, THE CONTRACTOR SHALL BEAR ALL EXTRA EXPENSE INVOLVED. INTERPRETATION OF ALL DOCUMENTS SHALL BE BY THE ENGINEER.
- .8 EXTRA WORK
  NO ADDITIONAL MONEY OVER CONTRACT PRICE SHALL BE PAID UNLESS CONTRACTOR RECEIVES A SIGNED APPROVAL IN ACCORDANCE WITH THE GENERAL CONDITIONS. NO ADDITIONAL MONEY SHALL BE PAID FOR USE
- .9 CUTTING AND PATCHING
  THE CONTRACTOR IS TO LOCATE THE EXACT DIMENSIONS AND POSITIONS OF OPENINGS AND HOLES WHERE
  CUTTING MAY BE REQUIRED IN FLOORS, ROOFS, CEILINGS AND/OR WALLS FOR THE PASSAGE OF PIPES, DUCTS,
  ETC. WHERE CUTTING, PATCHING, EXCAVATION AND BACKFILLING IS NECESSARY, IT SHALL BE DONE BY THIS
  CONTRACTOR.
- .10 SLEEVES

  THE CONTRACTOR IS TO SUPPLY AND SET IN PLACE PIPE AND/OR DUCT SLEEVES IN FLOOR, ROOF, OR FIRE WALLS BEFORE CONCRETE IS POURED.
- .11 SHOP DRAWNGS

  CONTRACTOR SHALL SUBMIT, WITHIN TWO WEEKS AFTER BEING AWARDED THE CONTRACT, A MINIMUM OF 6

  COPIES OF CERTIFIED SHOP DRAWINGS FOR REVIEW BY THE OWNER OF ALL EQUIPMENT AND MATERIAL

  SPECIFIED AND SHALL NOT PROCEED WITH ANY OF THIS WORK UNTIL THE DRAWINGS HAVE BEEN RETURNED

  STAMPED AND SIGNED. THIS REVIEW DOES NOT RELIEVE THE CONTRACTOR OF THE OBLIGATION OF CHECKING
  THE DRAWINGS OR FURNISHING THE MATERIALS SPECIFIED.
- .12 CLEANING UP
  THE CONTRACTORS SHALL, AT ALL TIMES, KEEP THE SITE NEAT, CLEAN AND FREE FROM ACCUMULATION OF WASTE, MATERIALS AND RUBBISH WHICH ARISE OUT OF THEIR WORK.
- EQUIPMENT OF THE FOLLOWING MANUFACTURERS, PROVIDING THE EQUIPMENT HAS EQUAL CHARACTERISTICS TO THAT SPECIFICALLY MENTIONED IN THIS SPECIFICATION, IS CONSIDERED AS EQUAL AND WILL BE ACCEPTED. THE OWNER HAS THE SOLE RIGHT TO DETERMINE AND INTERPRET THE 'EQUAL' QUALITIES. ANY MODIFICATIONS REQUIRED FOR INSTALLATION OF EQUAL PRODUCTS SHALL BE THE CONTRACTOR'S RESPONSIBILITY. EQUIPMENT OF MANUFACTURERS NOT MENTIONED IN THE 'REVIEWED EQUALS LIST', WHO WISH TO HAVE THEIR EQUIPMENT LISTED AS EQUAL, MAY QUALIFY FOR THE 'REVIEWED EQUALS LIST'. SUBMIT ALL REQUIRED TECHNICAL DATA THROUGH THE OFFICE OF THE GENERAL CONTRACTOR A MINIMUM OF TWO (2) DAYS PRIOR TO TENDER CLOSING.
- .14 OPERATING AND MAINTENANCE INSTRUCTIONS

  THE CONTRACTOR SHALL PROVIDE A MINIMUM 3 HOURS TO INSTRUCT THE OWNER IN OPERATION AND MAINTENANCE OF ALL EQUIPMENT AND SYSTEMS INSTALLED. ALL SAFETY AND CONTROL FEATURES SHALL BE THOROUGHLY EXPLAINED. THREE COPIES OF OPERATING AND MAINTENANCE INSTRUCTIONS, TOGETHER WITH ALL APPROVED SHOP DRAWINGS AND SPARE PARTS LIST FASTENED IN A BINDER, SHALL BE SUBMITTED TO THE OWNER.
- .15 AS BUILT DRAWINGS

  CONTRACTOR SHALL MAINTAIN, AT THE JOB SITE, ONE SET OF PLANS ON WHICH HE SHALL CLEARLY NOTE ALL CHANGES OR DEVIATIONS FROM THE CONTRACT DOCUMENTS, AS THE JOB PROGRESSES. CONTRACTOR SHALL AT THE TIME OF FINAL INSPECTION SUBMIT TO THE OWNER, ONE SET OF FINAL 'AS-BUILT' WHITE PRINT
- .16 FIRE STOPPING

  MECHANICAL CONTRACTORS SHALL PROVIDE AND INSTALL A ULC LISTED FIRE STOPPING DEVISE AT FIRE SEPARATION FOR MECHANICAL SYSTEMS WHERE SUCH SYSTEMS PENETRATE FIRE AND SMOKE SEPARATIONS AND RATED ASSEMBLIES IN THE STRUCTURE AS INDICATED ON ARCHITECTURAL DRAWINGS OR REQUIRED BY AUTHORITIES HAVING JURISDICTION. ACCEPTABLE FIRE STOP SYSTEM SHALL BE BY HILTI OR APPROVED EQUAL. INSTALLATION OF FIRE STOPPING SYSTEM SHALL BE IN ACCORDANCE WITH MANUFACTURERS LISTED TEST PROCEDURE. INSTALLER SHALL BE TRAINED AND CERTIFIED BY MANUFACTURER. FIRE STOPPING SHALL BE INSTALLED AS PER MANUFACTURERS APPROVED INSTALLATION REQUIREMENTS AND SHALL BE INSPECTED PRIOR TO ENCLOSING WALLS OR CEILINGS WHERE FIRE STOPPING HAS BEEN INSTALLED.

#### **VENTILATION SYSTEMS**

- .1 DUCTWORK ALL DUCTWORK SHALL BE CONSTRUCTED FROM LOCK FORMING QUALITY STEEL WITH G90 DESIGNATION ZINC COATING TO ASTM A-525M-80 IN ACCORDANCE WITH THE LATEST EDITION OF ASHRAE GUIDE AND SMACNA STANDARDS. DUCT LEAKAGE SHALL NOT EXCEED 3% MAXIMUM. SEAL ALL DUCTS WITH APPROVED SEALANT.
- 2 HANGERS HANGER SPACING SHALL BE AS PER THE FOLLOWING SCHEDULE:

| LONGEST SIDE                    | GAUGE<br>(US) | TYPE OF JOINTS |      |          |      |     |
|---------------------------------|---------------|----------------|------|----------|------|-----|
| LONGEST SIDE                    |               | HEIGHT         | SLIP | BAR SLIP | LOCK | 'T' |
| UP TO 11"<br>(275mm)            | 26            | 25             | 24   | ı        | 24   | ı   |
| 12" (300mm) TO<br>24" (600mm)   | 24            | 25             | 22   | -        | 22   | ı   |
| 25" (625mm) T0<br>60" (1500mm)  | 22            | 25             | 1    | 22       | 22   | 22  |
| 61" (625mm) TO<br>108" (2700mm) | 20            | 37             | 1    | 22       | 22   | 22  |

- .3 FLEXIBLE CONNECTIONS

  PROVIDE, WHERE SHOWN AND AT ALL DUCT CONNECTIONS TO EQUIPMENT, NEOPRENE COATED GLASS FABRIC,

  DURO—DYNE OR EQUAL, NOT MORE THAN 4" (100 MM) LONG BETWEEN METAL PARTS AND INSTALLED WITH

  SUFFICIENT SLACK TO PREVENT VIBRATION TRANSMISSION.
- .4 DUCT SEALING
  ALL NEW SHEET METAL DUCTWORK SHALL BE DUCT SEALED WITH DUCT SEALANT AND FIBERGLASS MESH
  TAPE INCLUDING CONNECTIONS TO EXISTING DUCTWORK. ALL EXISTING SUPPLY AND EXHAUST DUCTWORK
  WITHIN THE SCOPE OF WORK AREA TO HAVE JOINTS AND LONGITUDINAL SEAMS SEALED. DUCT SEALANT:
  DURODYNE WB-S2.
- PROVIDE FIRE DAMPERS WERE SHOWN AND WHERE REQUIRED BY AUTHORITIES HAVING JURISDICTION TO MAINTAIN FIRE WALL OR CEILING INTEGRITY, THEY SHALL BE CONTROLLED AIR MFG LTD MODEL 'B', OR EQUAL. FIRE DAMPERS TO BE "DYNAMIC" FIRE DAMPERS SHALL BE LISTED AND BEAR THE LABEL OF ULC AND SHALL MEET REQUIREMENTS AND BE INSTALLED TO NFPA 90A-1978 AND SMACNA STANDARD 'FIRE DAMPER GUIDE FOR AIR HANDLING SYSTEMS'. SEAL WALL OPENINGS ALL AROUND THE DUCTS PASSING THROUGH THE FIRE WALLS AS RECOMMENDED BY THE NFPA-13. PROVIDE ACCESS DOORS AT EACH FIRE DAMPER TO ALLOW FOR SERVICE. TEST OPERATION OF EACH DAMPER ONCE INSTALLED TO VERIFY PROPER FUNCTION.

#### **AUTOMATIC SPRINKLER SYSTEM**

- 1 REFERENCES

  SPRINKLER SYSTEM TO BE INSTALLED AS PER ANSI/NFPA 13 LATEST ACCEPTED EDITION, NATIONAL BUILDING CODE OF CANADA LATEST EDITION. NATIONAL FIRE CODE OF CANADA LATEST EDITION. THE NATIONAL PLUMBING CODE LATEST EDITION, AND THE PROVINCE OF NEW BRUNSWICK OFFICE OF THE FIRE MARSHALL.
- .2 SHOP DRAWINGS AND PRODUCT DATA
  SUBMIT SHOP DRAWINGS AND PRODUCT DATA IN ACCORDANCE WITH THE NFPA 13, WORKING PLANS AND DESIGN REQUIREMENTS. SUBMIT SHOP DRAWINGS TO THE OWNER FOR REVIEW.
- .3 ENGINEERING DESIGN CRITERIA
  DESIGN SYSTEM TO ACCORDANCE WITH NFPA-13, USING FOLLOWING PARAMETERS
- .1 ALL AREAS LIGHT HAZARD
  .2 IN ACCORDANCE WITH AUTHORITIES HAVING JURISDICTION
  .2 PIPE SIZE AND LAYOUT:
- .1 SCHEDULE DESIGN SIZED TO LIGHT HAZARD,
  .2 SPRINKLER HEAD LAYOUT: TO NFPA-13 OR AS DIRECTED BY AUTHORITIES HAVING JURISDICTION.
- .4 CONTRACTORS QUALIFICATIONS

  ALL WORK RELATED TO THE AUTOMATIC SPRINKLER SYSTEM SHALL BE PERFORMED BY A COMPETENT CONTRACTOR WHO IS EXPERIENCE IN THE SPRINKLER TRADE. SAID CONTRACTOR SHALL HAVE A FOREMAN ON SITE WHO HOLDS A VALID CERTIFICATE OF QUALIFICATION FOR SPRINKLER SYSTEMS INSTALLATION AS ISSUED BY THE DEPARTMENT OF LABOR, PROVINCE OF NEW BRUNSWICK. IN ADDITION, ALL SPRINKLER TRADESMEN WORKING ON THE SITE SHALL HOLD A VALID CERTIFICATE OF QUALIFICATIONS FOR SPRINKLER INSTALLATION AS ISSUED BY NEW BRUNSWICK DEPARTMENT OF LABOR, OR BE REGISTERED WITH THE DEPARTMENT OF LABOR AS IN TRAINING FOR A CERTIFICATE OF QUALIFICATION FOR SPRINKLER INSTALLATION.

#### .5 PIPE & FITTINGS .1 PIPE & FITTINGS:

- STEEL PIPE: SCHEDULE 40 FOR SIZES UNDER NPS 8, BLACK OR GALVANIZED, TO ASTM A53 LATEST EDITION. THREADED JOINTS SHALL BE ON SCHEDULE 40 ONLY.
   STEEL PIPE: WELDED OR SEAMLESS STEEL PIPE SCHEDULE 10 FOR SIZES UP TO NPS 5.
- .2 FITTINGS: 175PSI WORKING PRESSURE.
  .1 CAST IRON SCREWED TO ANSI B16.4—LATEST EDITION, 125PSI.
- .2 MALLEABLE IRON, SCREWED TO ANSI B16.3 LATEST EDITION, 125PSI.
  .3 CAST IRON FLANGED TO ANSI B16.1 LATEST EDITION, 145PSI
- .4 MECHANICAL GROOVE COUPLING TO ANSI B31.3 LATEST EDITION, 175PSI. .5 MITRED FITTINGS ARE UNACCEPTABLE.
- .3 ALL ROLL GROOVED FITTINGS TO BE ULC LISTED FOR FIRE PROTECTION SERVICES AND BE OF ONE MANUFACTURER. ALL COUPLINGS TO BE DESIGNED WITH AN ANGLE BOLT PAD TO PROVIDE A RIGID JOINT. ACCEPTABLE MATERIAL: VICTAULIC FIRE LOCK 005
- TO CONFORM TO NFPA 13—LATEST EDITION FOR INSTALLATION OF SPRINKLER SYSTEMS
- PENDENT / UPRIGHT TYPE TO SUIT INSTALLATION. RATINGS TO NFPA 13.
- INSTALL, INSPECT, AND TEST SYSTEM TO ACCEPTANCE IN ACCORDANCE WITH NFPA 13. NOTE THAT BUILDING SPRINKLER SYSTEM TO BE LEFT IN OPERATION AT END OF EACH WORK DAY. SHUT DOWN TO BE SCHEDULED WITH BUILDING OPERATIONS MANAGER AND SHALL BE APPROVED PRIOR TO ANY WORK COMMENCING.
- OCORDINATION

  DRAWINGS INDICATE NEW SPRINKLER HEAD LOCATIONS ONLY. CONTRACTOR TO PROVIDE A DESIGNED PIPING LAYOUT TO SUIT NEW SPRINKLER HEAD LOCATIONS. THE PIPING LAYOUT SHALL BE COORDINATED WITH EXISTING AND NEW SERVICES LOCATED ABOVE THE CEILING. MODIFY / ADD PIPING AS REQUIRED.
- SPRINKLER CONTRACTOR SHALL PERFORM A PRESSURE TEST ON ALL NEW SPRINKLER PIPING INSTALLED. TEST PRESSURE SHALL BE TO 200 PSI FOR 2 HOURS WITH NO DROP IN PRESSURE IN ACCORDANCE WITH NFPA. TEST TO BE WITNESSED BY OWNER AND A TEST REPORT SUBMITTED BY CONTRACTOR DATED AND SIGNED TO OWNER. PROVIDE LETTER AT COMPLETION OF JOB STATING THAT SPRINKLER SYSTEM HAS BEEN LEFT IN

#### PLUMBING SYSTEMS

.1 GENERAL


ALL PLUMBING SHALL BE INSTALLED IN ACCORDANCE WITH THE NATIONAL PLUMBING CODE OF CANADA, LATEST EDITION. CONTRACTOR SHALL CONDUCT AND PAY FOR ALL PERMITS AND TESTS. ALL TESTS SHALL BE CARRIED OUT IN THE PRESENCE OF THE ENGINEER OR HIS REPRESENTATIVE AND/OR AUTHORITY HAVING JURISDICTION.


| .2 PIPE | MATERIAL  |       |    |    |           |      |     |
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| PIPE    | MATERIALS | SHALL | BE | AS | SPECIFIED | BELC | )W: |
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| PIPE MATERIALS SHALL BE AS SPECIFIED BELO                   | DW:  |
|---|--|
| SANITARY/STORM DRAINAGE BELOW GROUND                        | M.W. CAST IRON CLASS 4000 TO CSA-B70.<br>ABS-DWV,PVC-DWV TO CSA-B181.1, B181.2, AND B182.1 |
| SANITARY/STORM DRAINAGE ABOVE<br>GROUND 3" (75mm) & LARGER  | M.W. CAST IRON CLASS 4000 TO CSA-B70.<br>PVC-DWV*,XFR TO CSA-B181.2                        |
| SANITARY/STORM DRAINAGE ABOVE<br>GROUND 2" (50mm) & SMALLER | COPPER-DWV TO CSA-B125.<br>PVC-DWV*,XFR TO CSA B-181.2                                     |
| SANITARY VENT   | COPPER-DWV TO CSA-B125.<br>PVC-DWV*,XFR TO CSA B-181.2                                     |
| DOMESTIC HOT & COLD<br>WATER (INSIDE BUILDING)              | COPPER TYPE 'L' HARD TO ASTM B88M. PEX-A* TO CSA-B137.5/B137.6. CPVC TO CSA-B137.6         |


\* PVC OR OTHER COMBUSTIBLE PIPING WITH A SMOKE-DEVELOPMENT RATING GREATER THAN 50 SHALL NOT BE USED WHERE CEILINGS ARE USED AS AIR PLENUMS. IPEX XFR SYSTEM IS RATED FOR PLENUM INSTALLATION.

COMBUSTIBLE PIPING IS PERMITTED FOR USE IN NON-COMBUSTIBLE CONSTRUCTION ONLY WHERE CONCEALED IN A WALL OR CONCRETE FLOOR SLAB, OR HAVING A FLAME-SPREAD RATING NOT GREATER THAN 25. FOR 'HIGH BUILDINGS' AS DEFINED PER NBC, THE SMOKE-DEVELOPMENT RATING SHALL ALSO NOT BE GREATER THAN 50. FLAME-SPREAD AND SMOKE DEVELOPMENT CAN/ULC-S102.2 TESTING STANDARD.



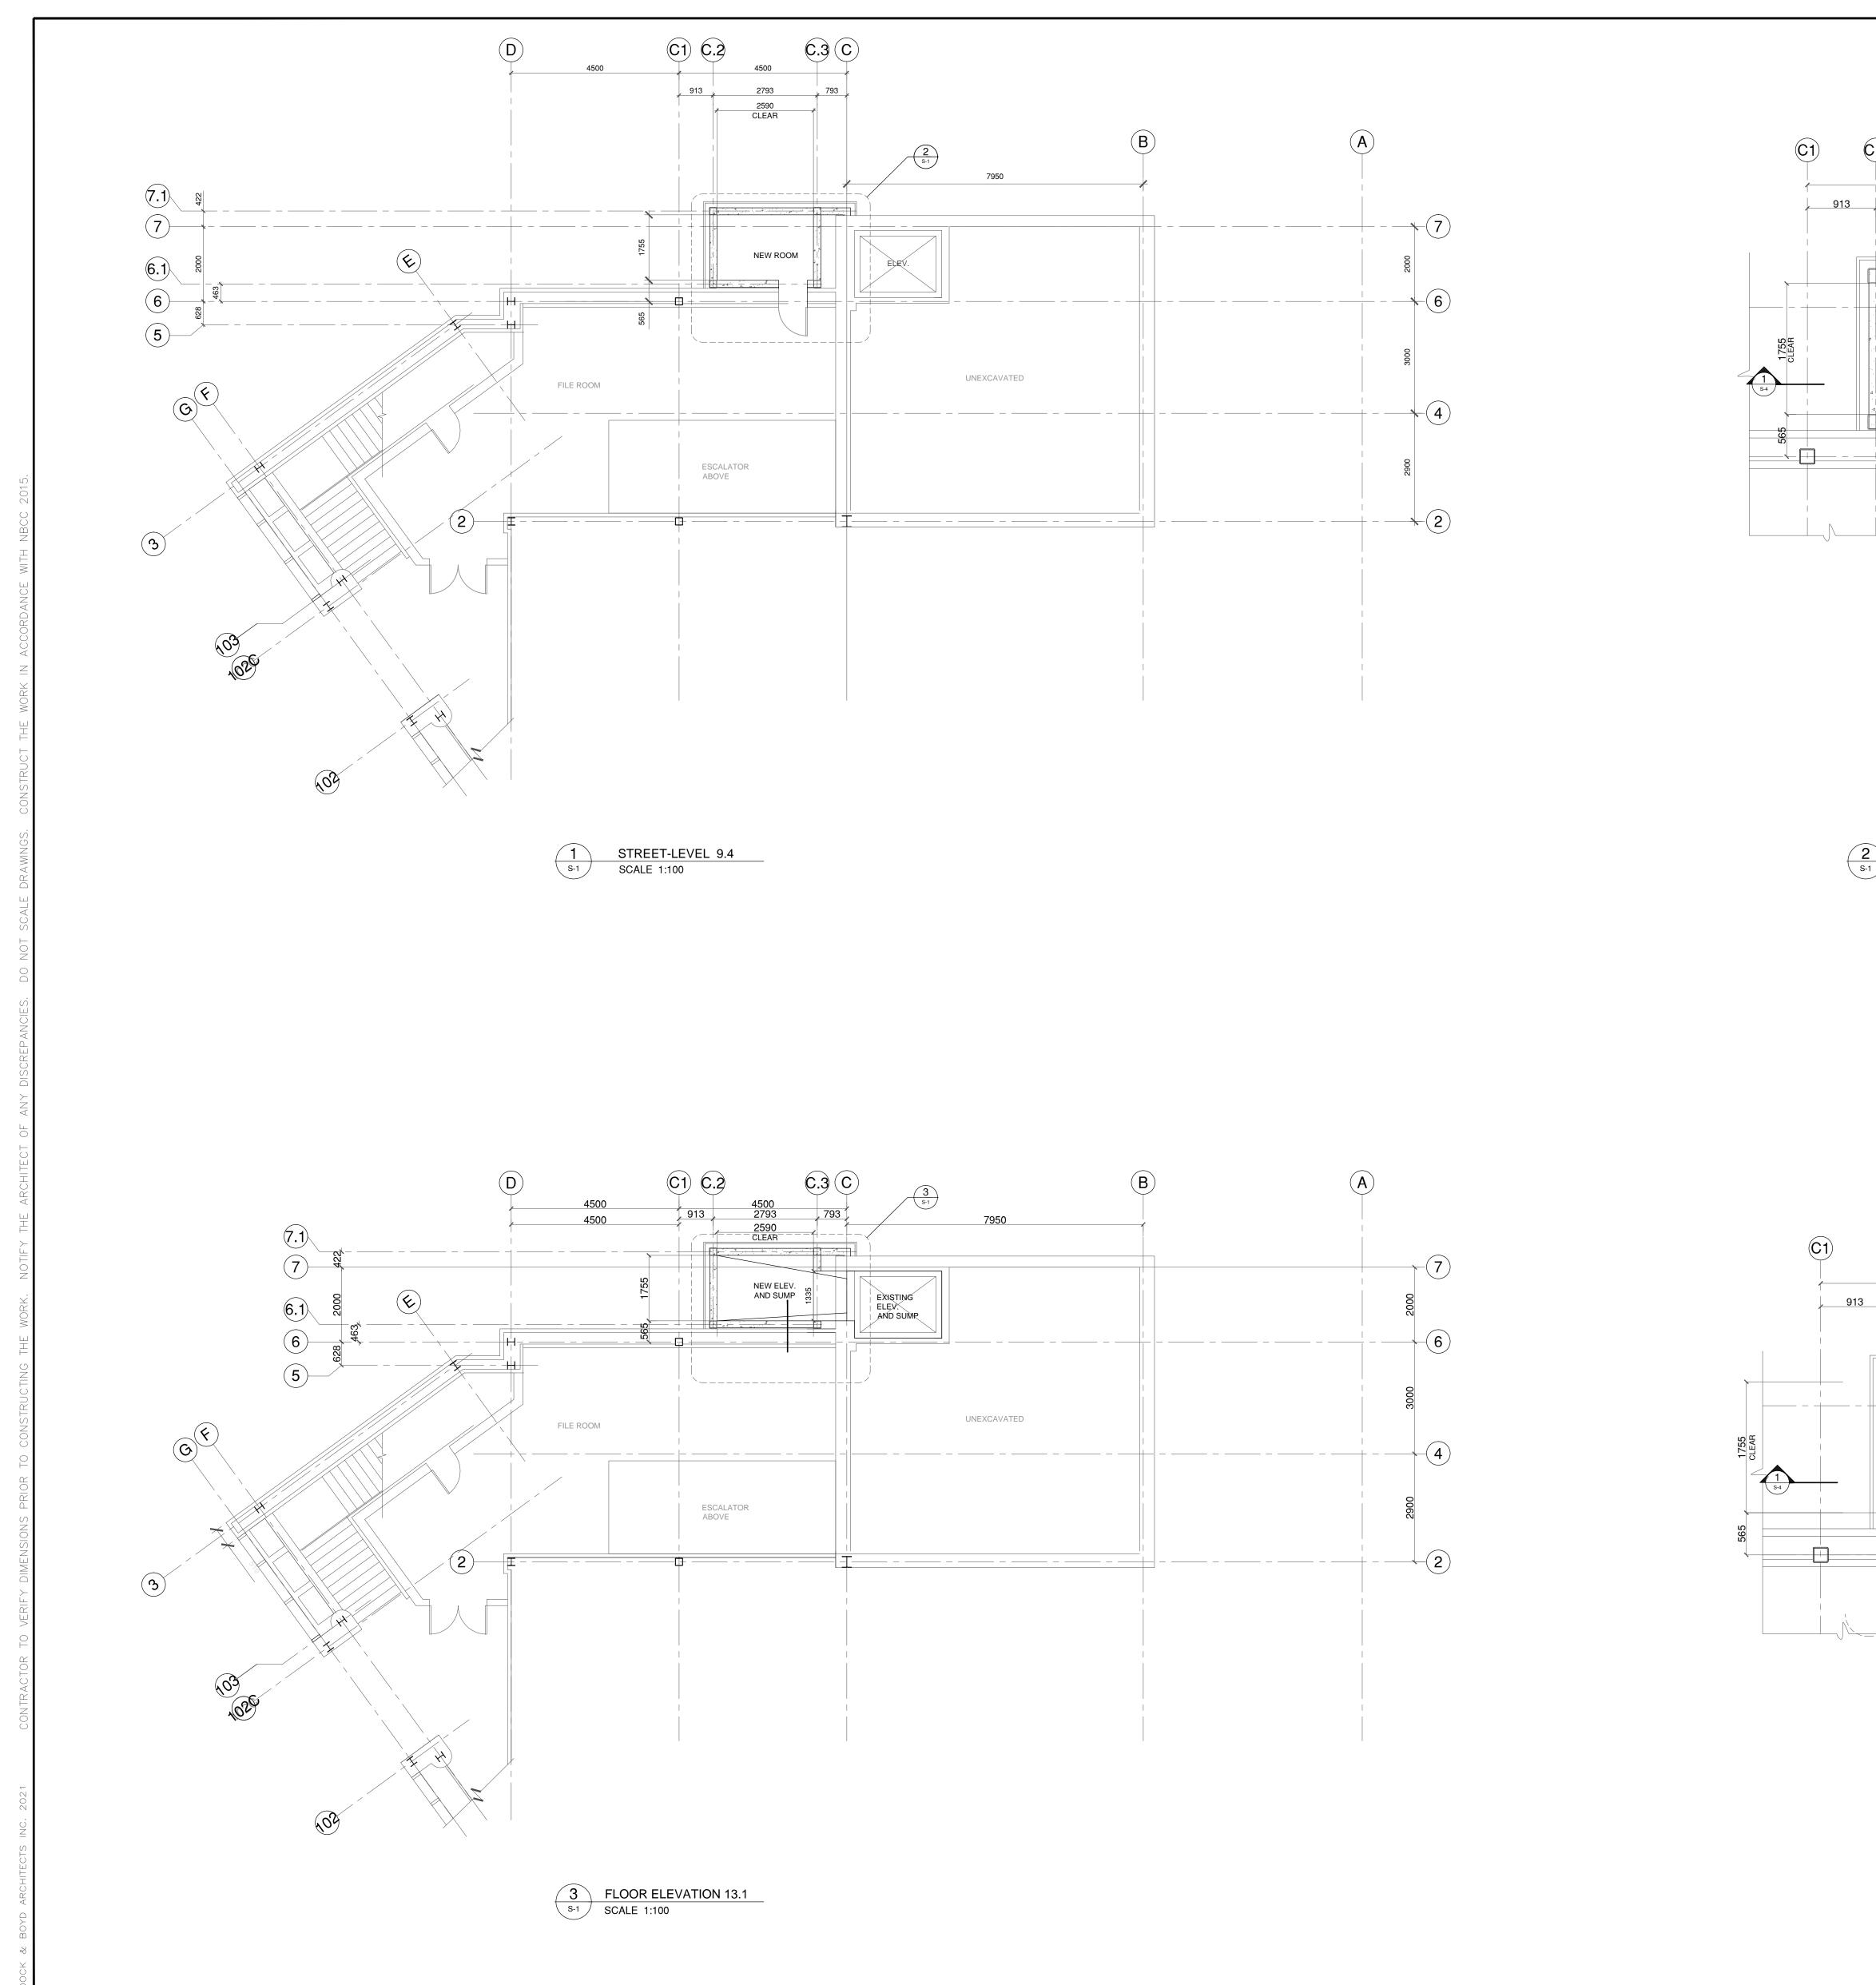

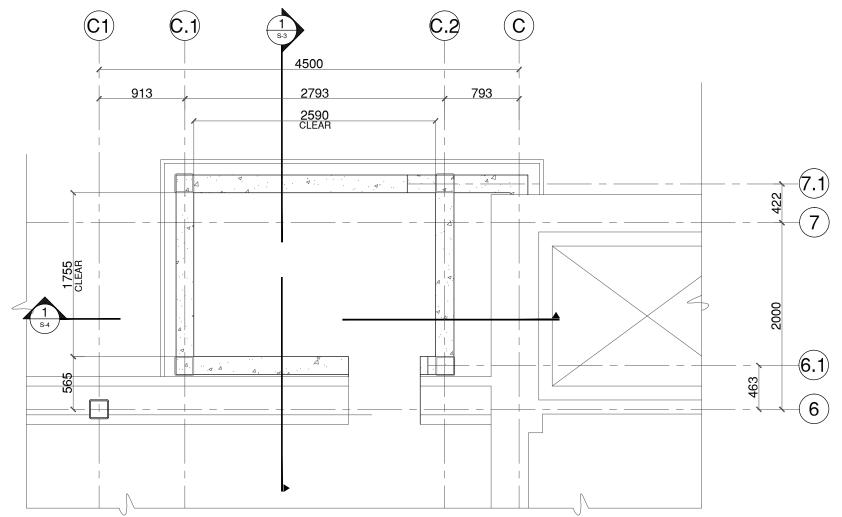


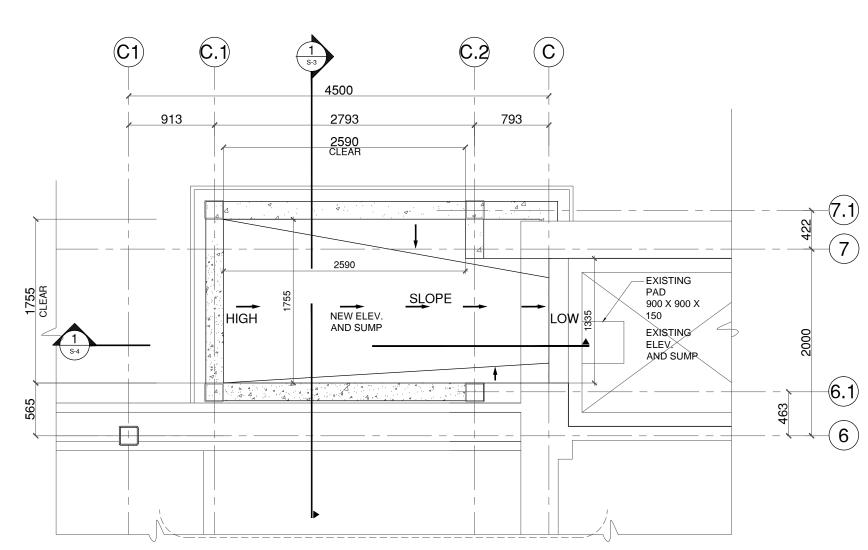








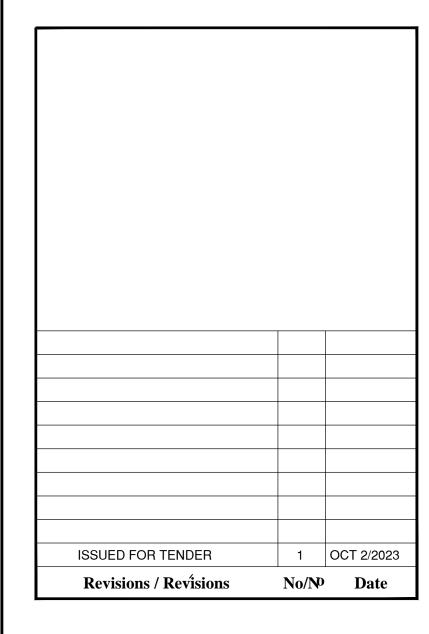




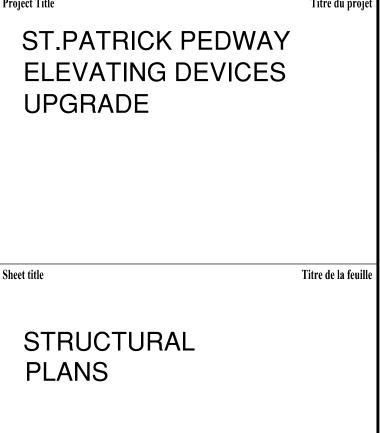


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| by Approuvé par<br>3 H                           |       | Signature<br>October 2 2023   |      |
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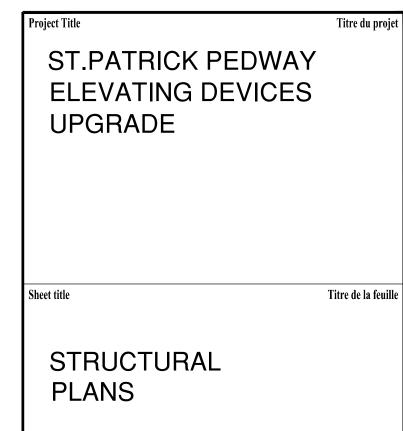




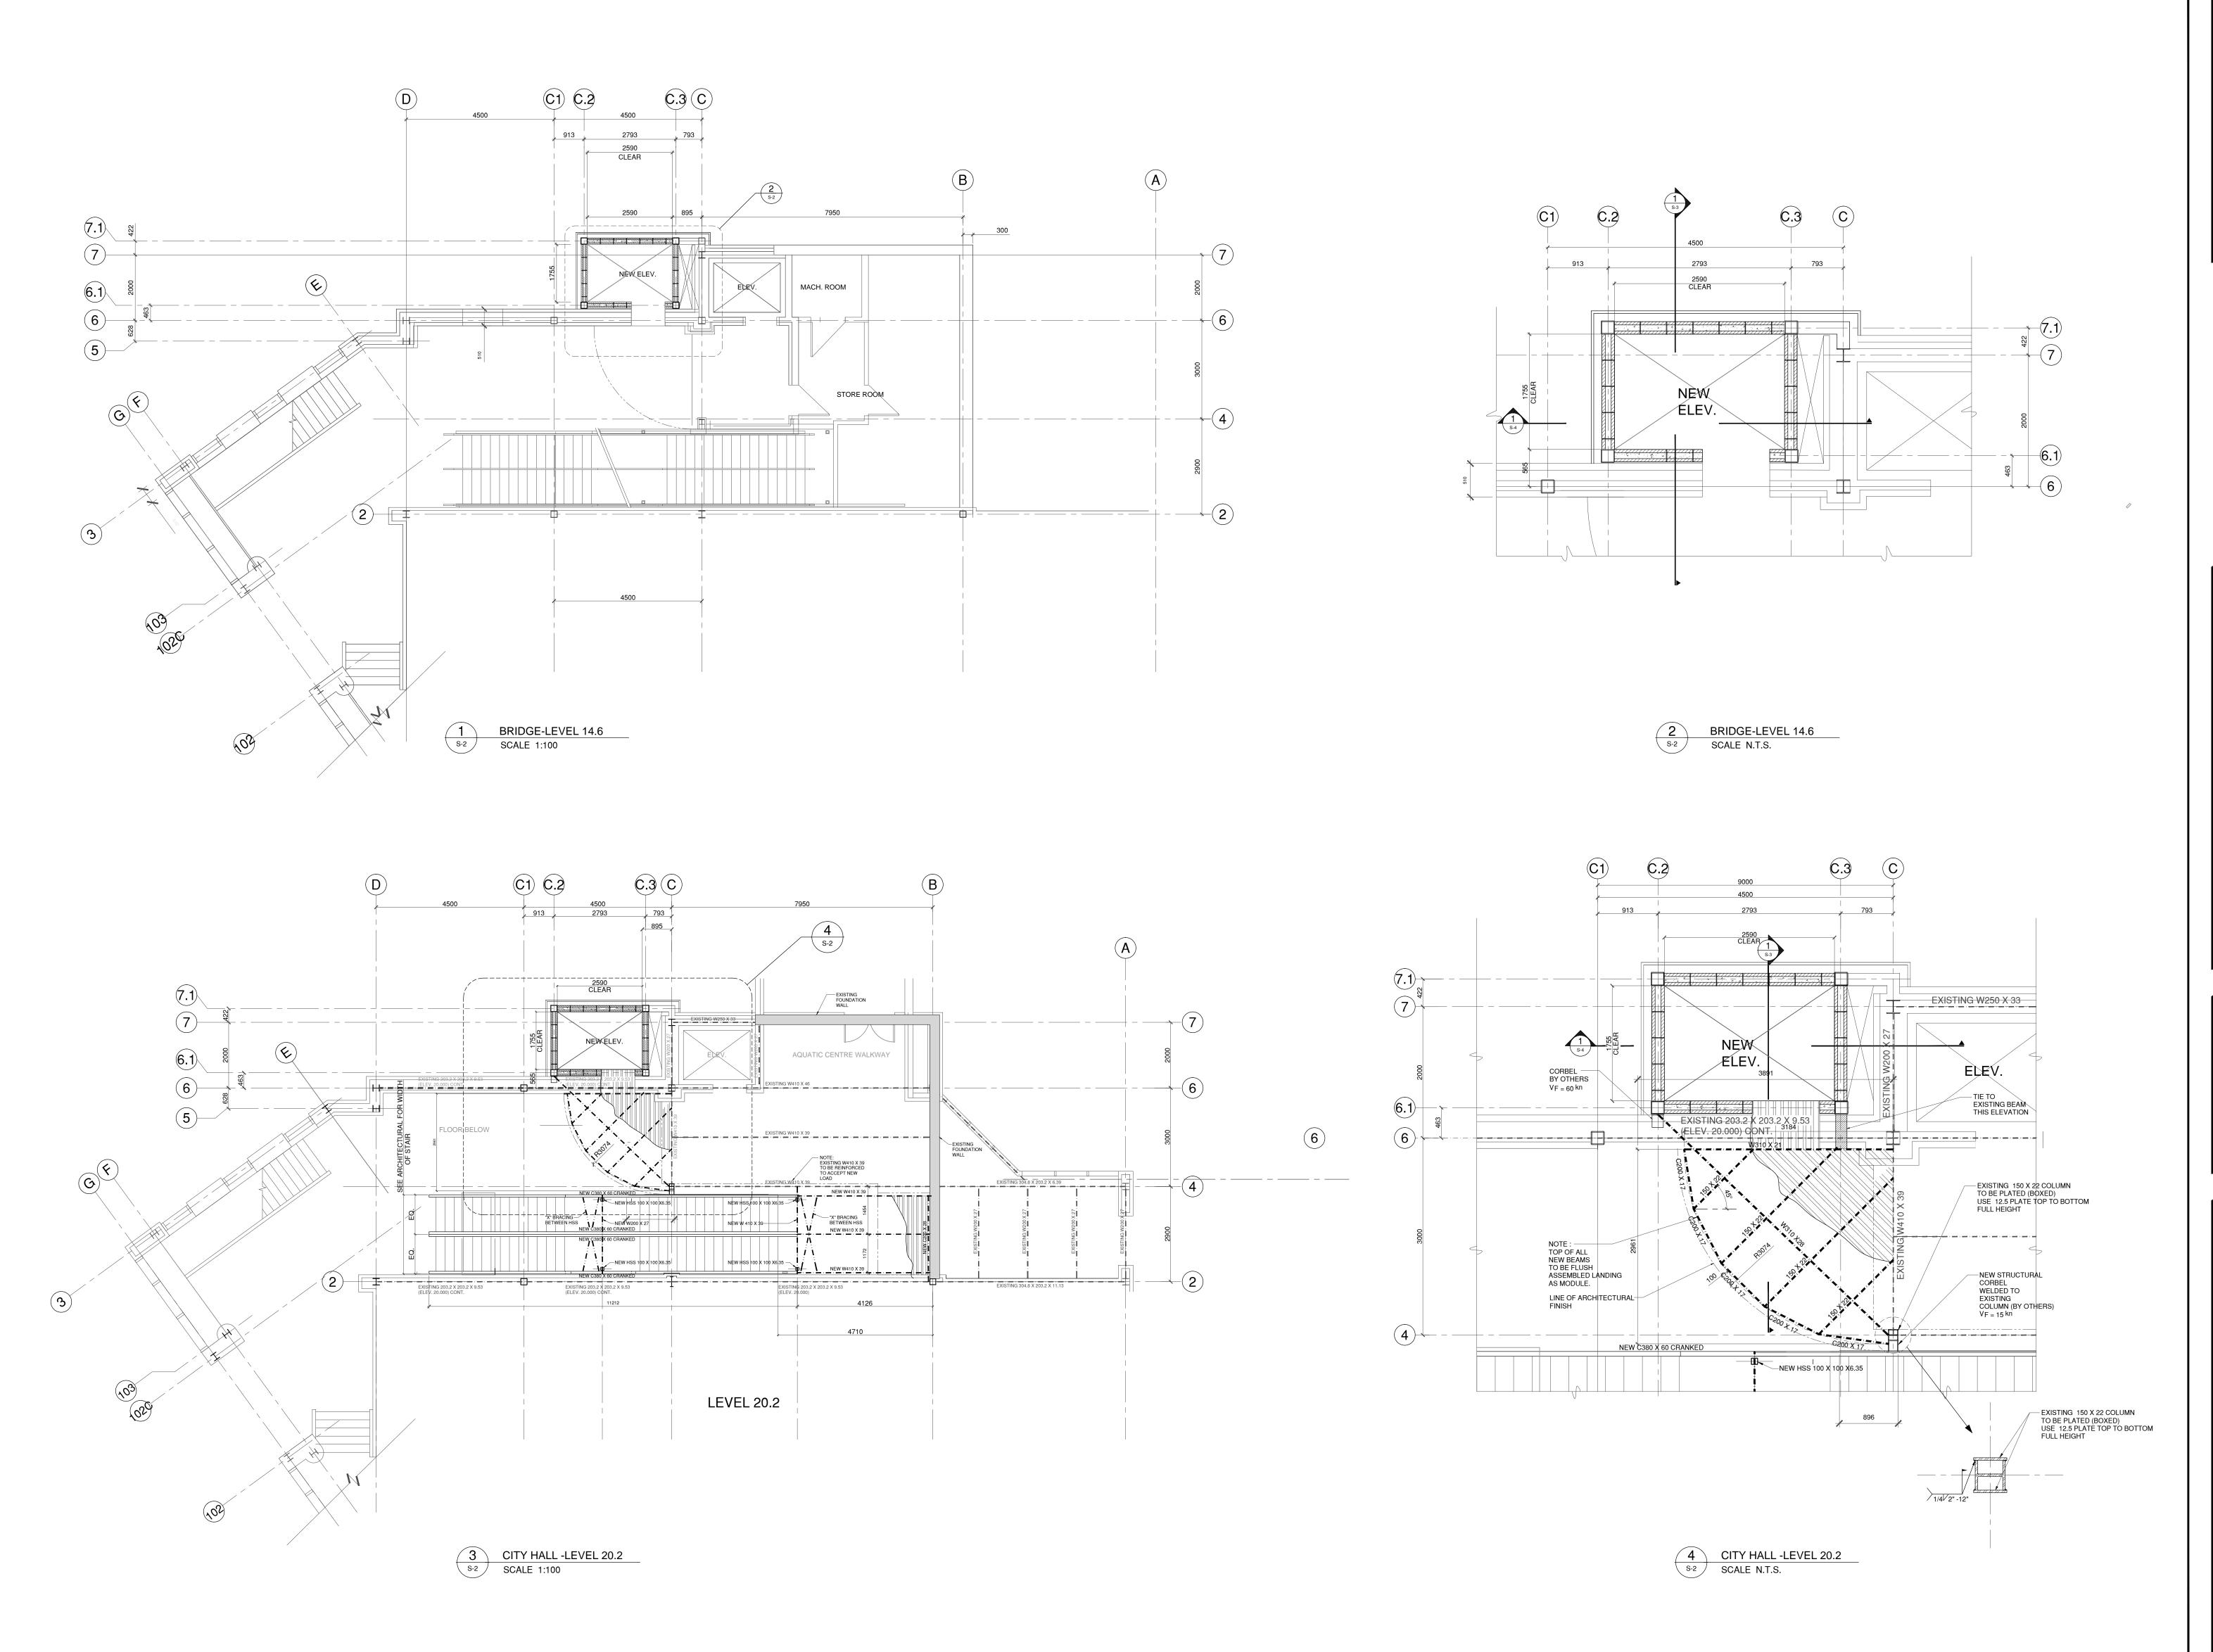






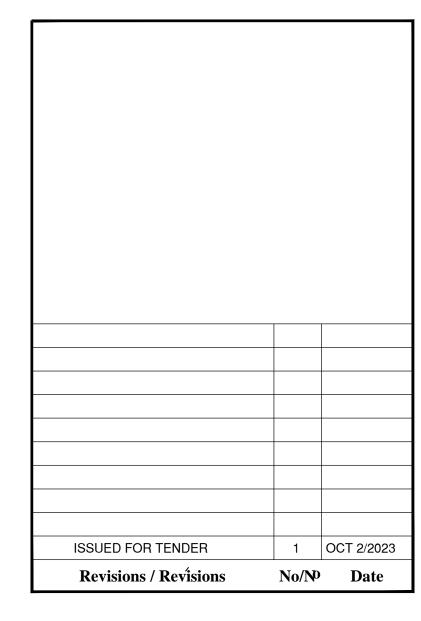


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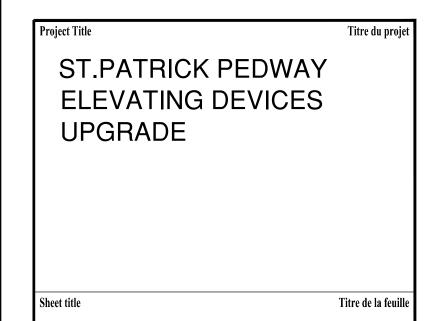
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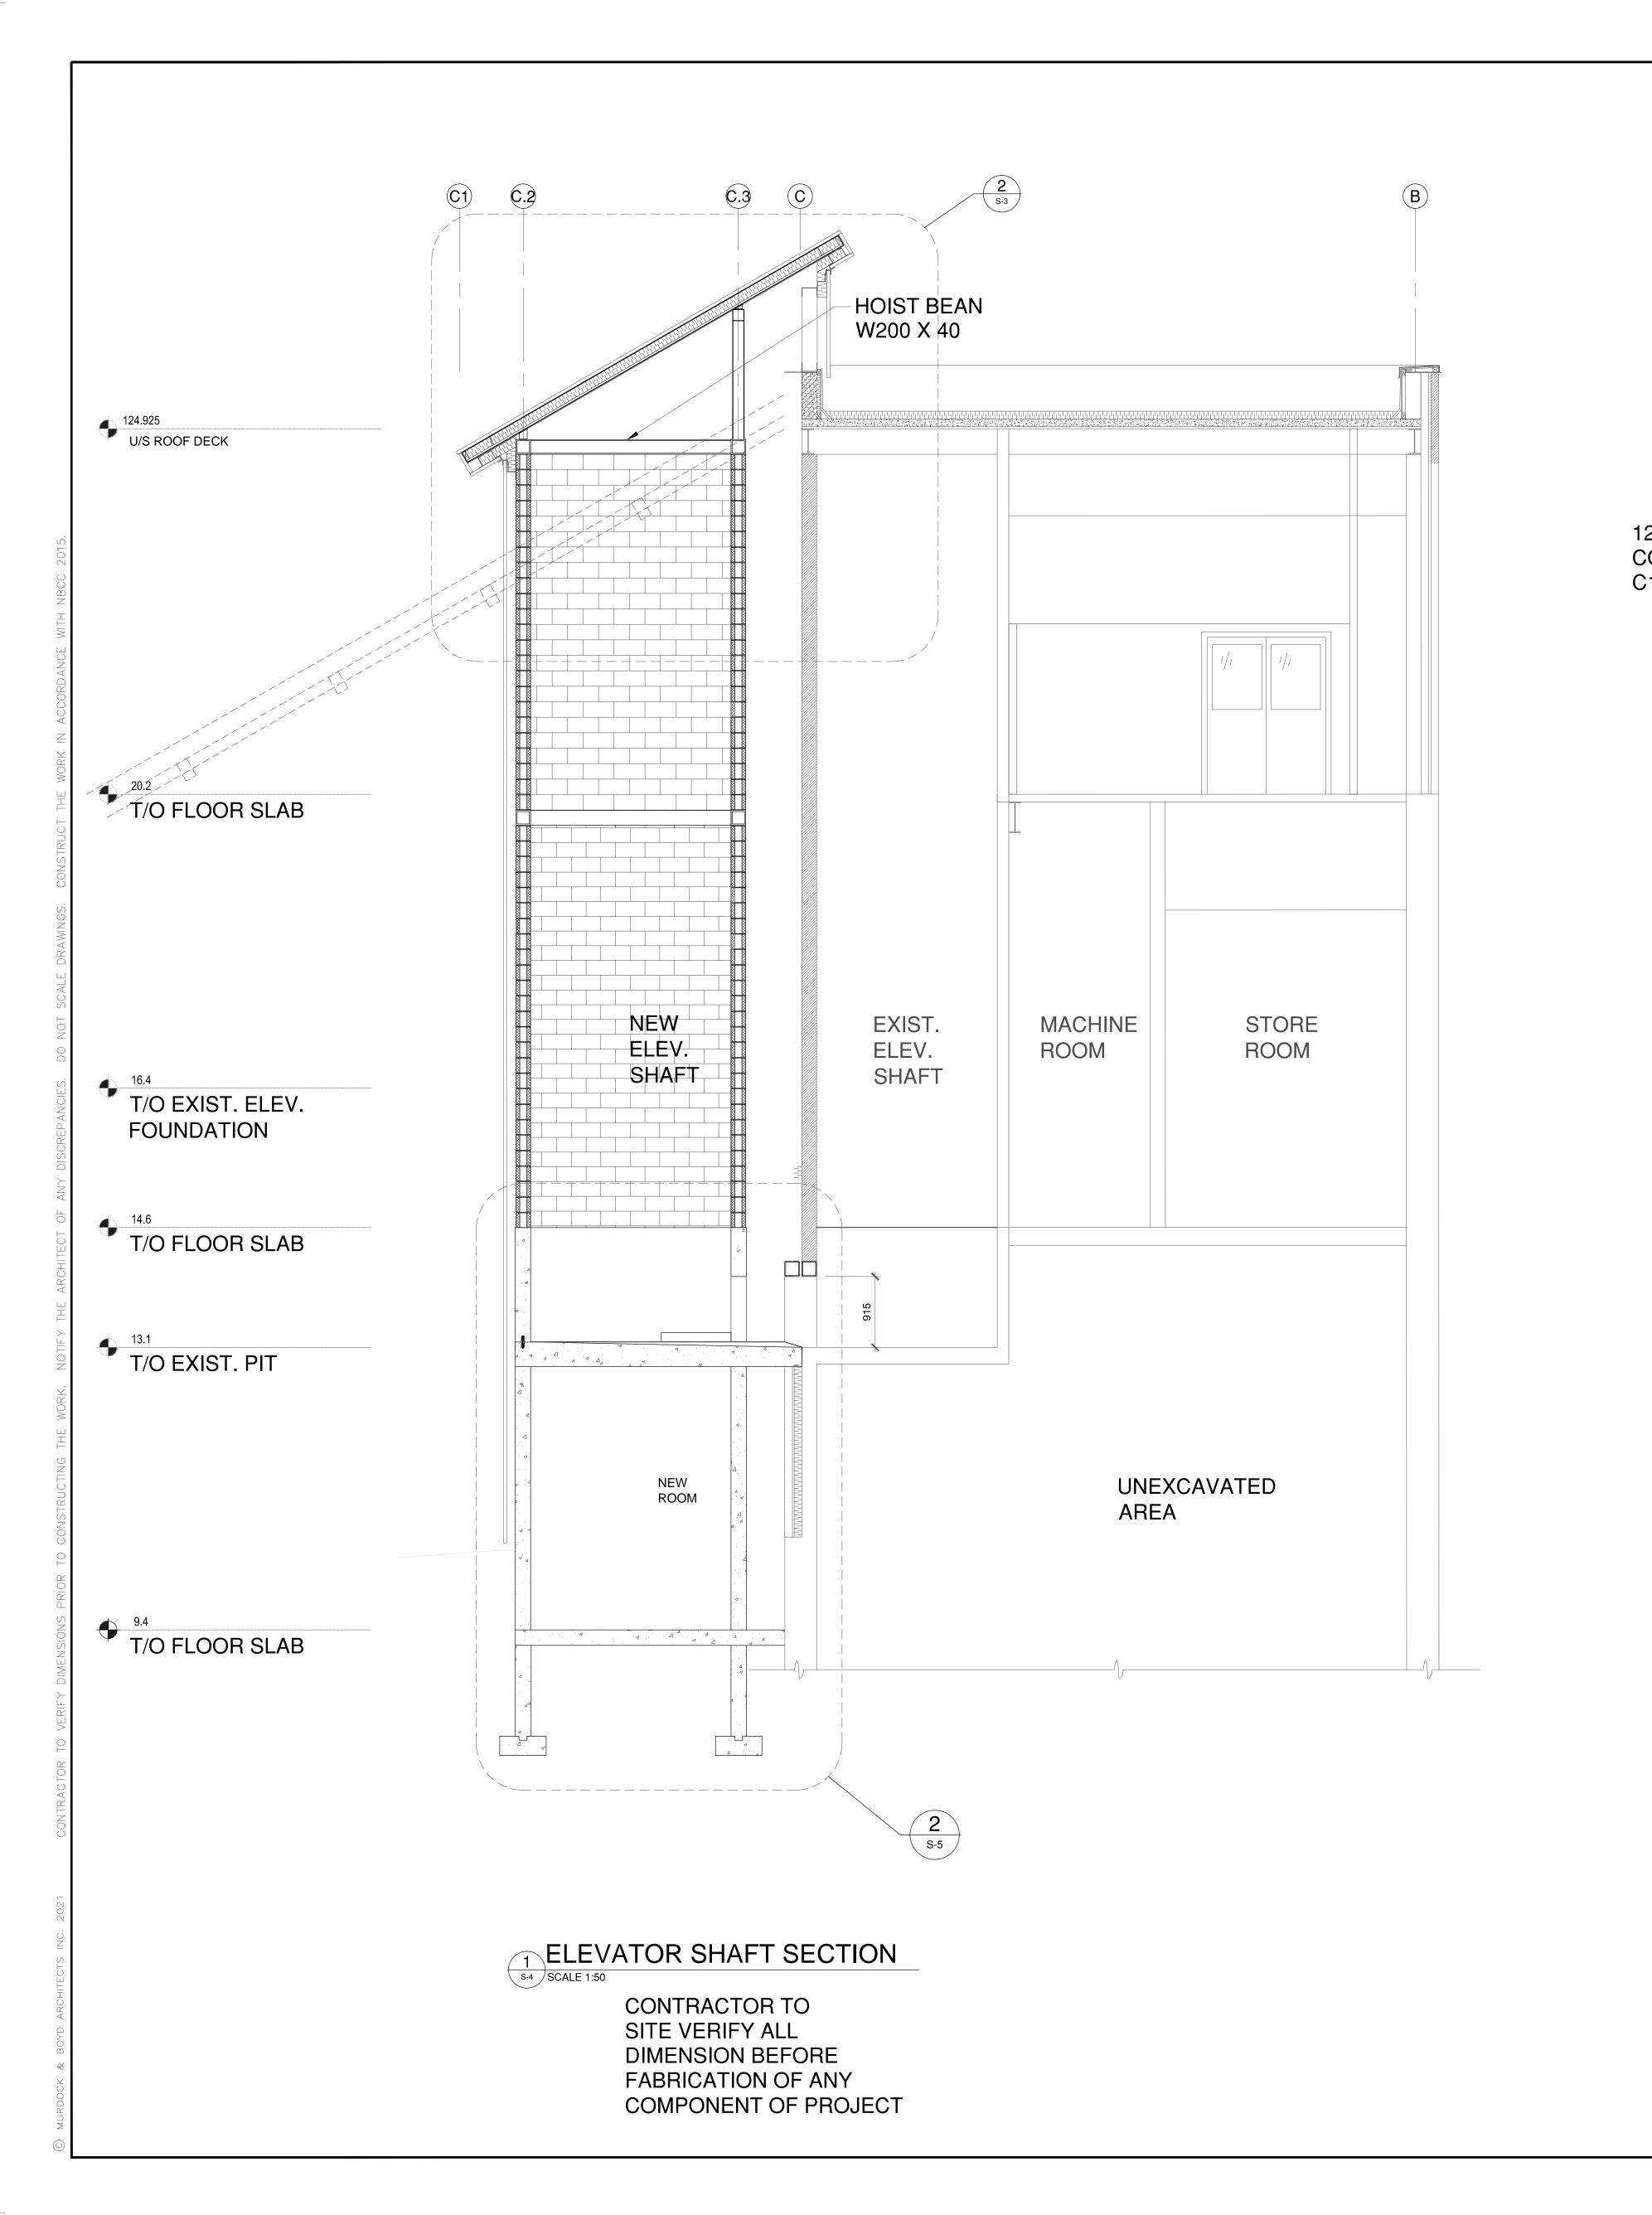





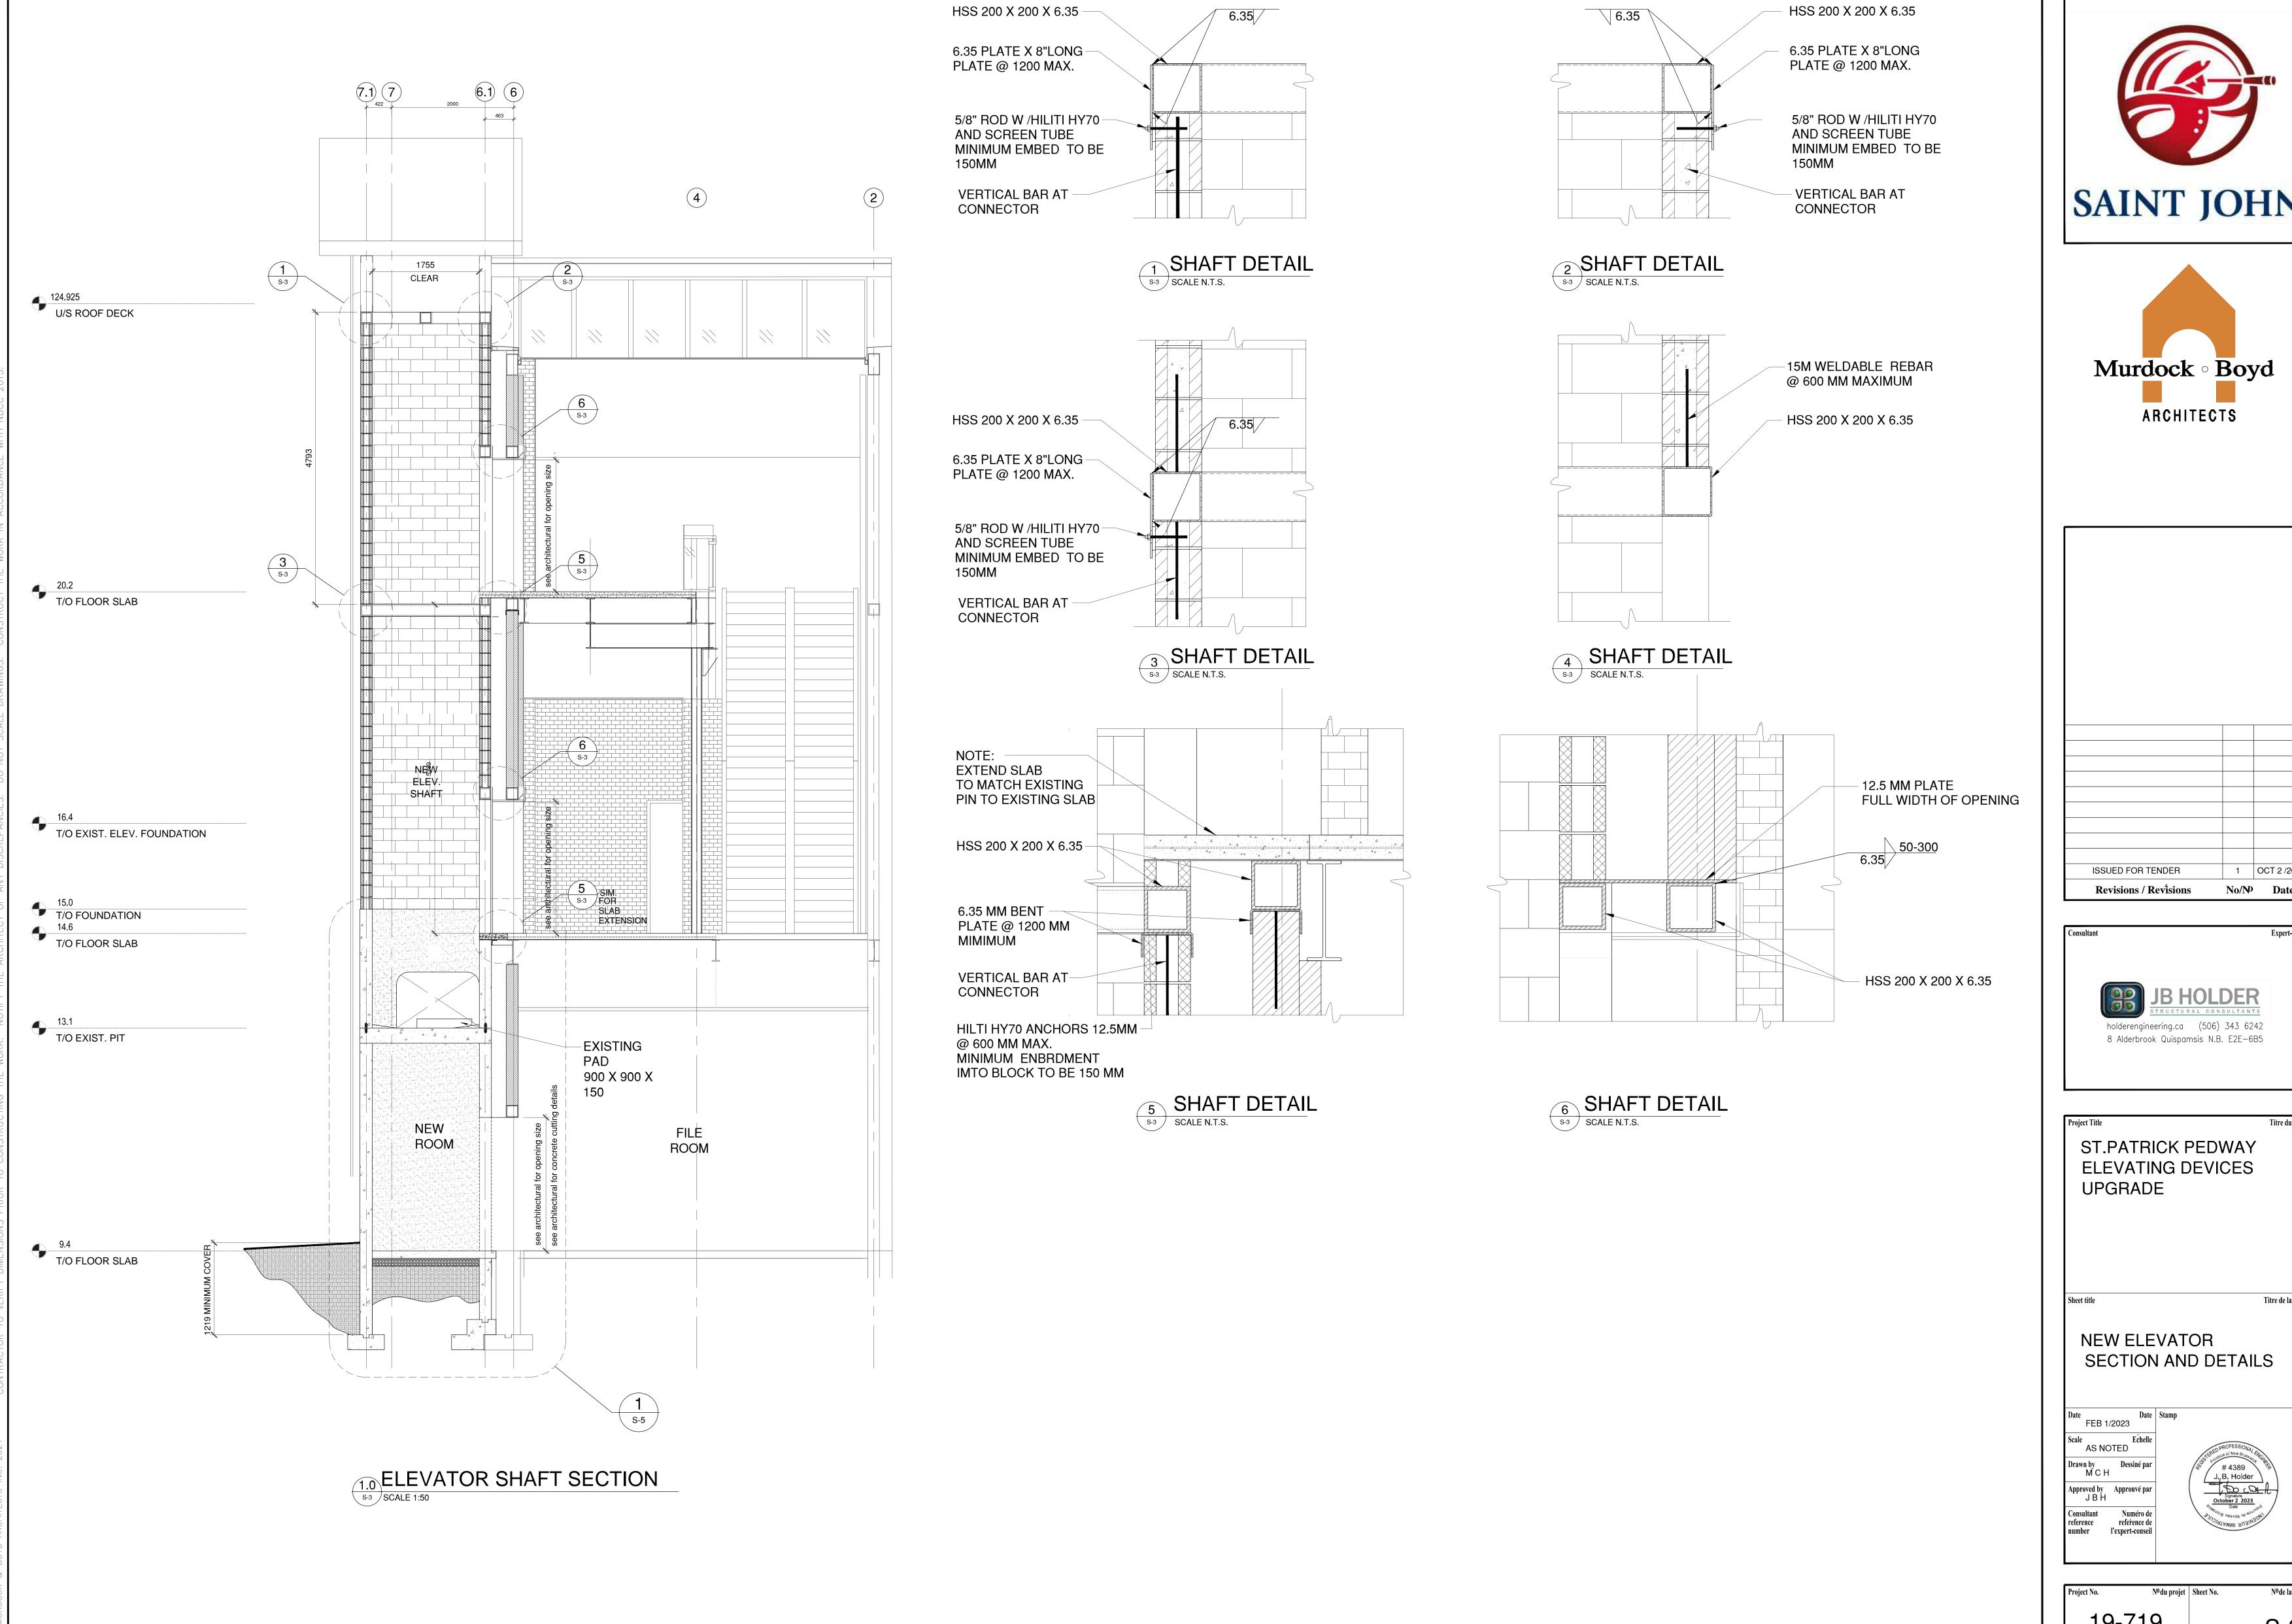

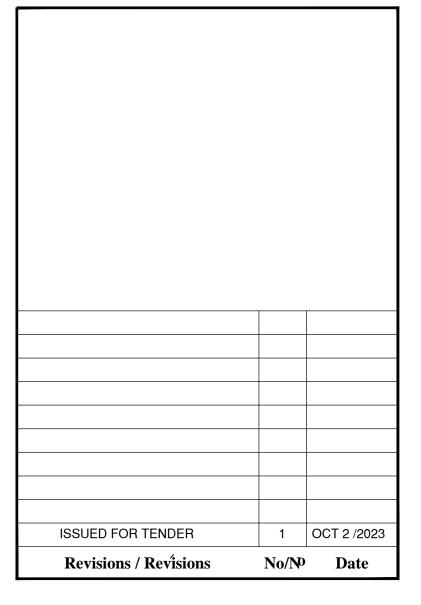

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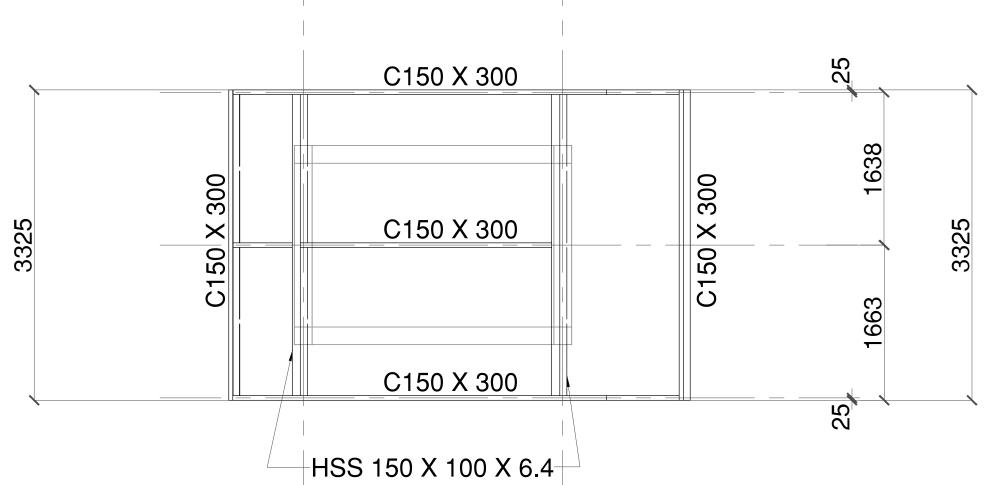


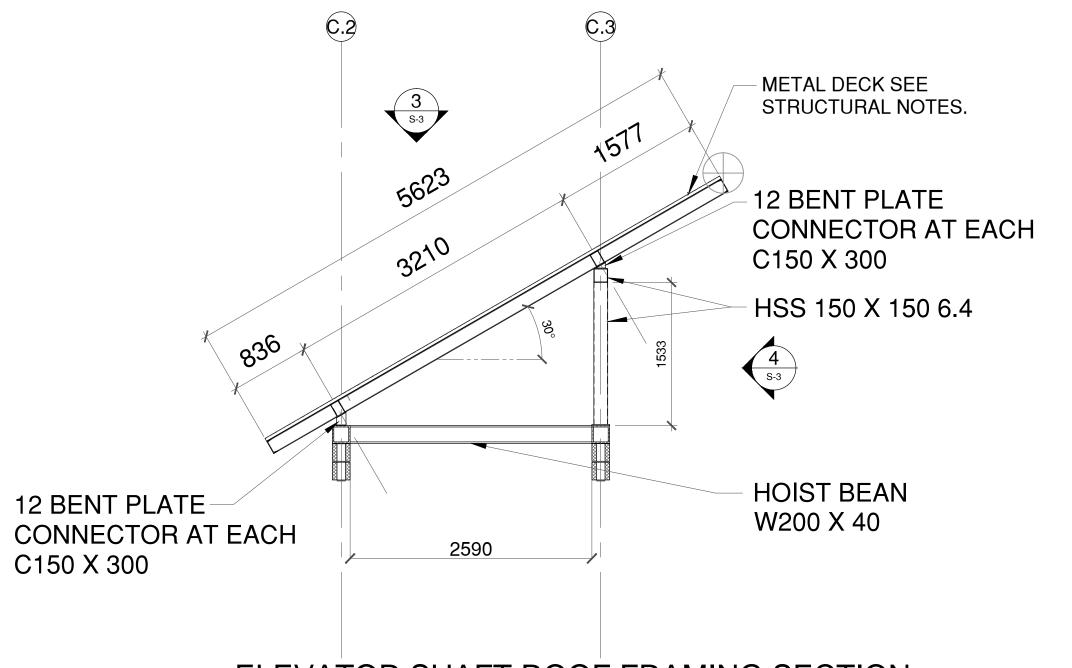

ELEVATOR SHAFT ROOF FRAMING SECTION


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CONTRACTOR TO
SITE VERIFY ALL
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FABRICATION OF ANY
COMPONENT OF PROJECT



# 3 ELEVATOR SHAFT ROOF FRAMING PLAN SCALE N.T.S. CONTRACTOR TO

CONTRACTOR TO
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COMPONENT OF PROJECT

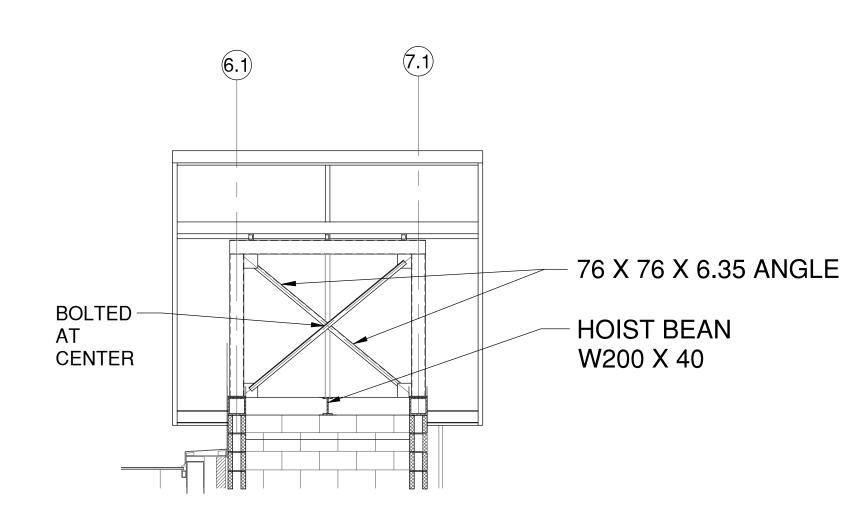


ELEVATOR SHAFT ROOF "X" BRACING ELEVATION


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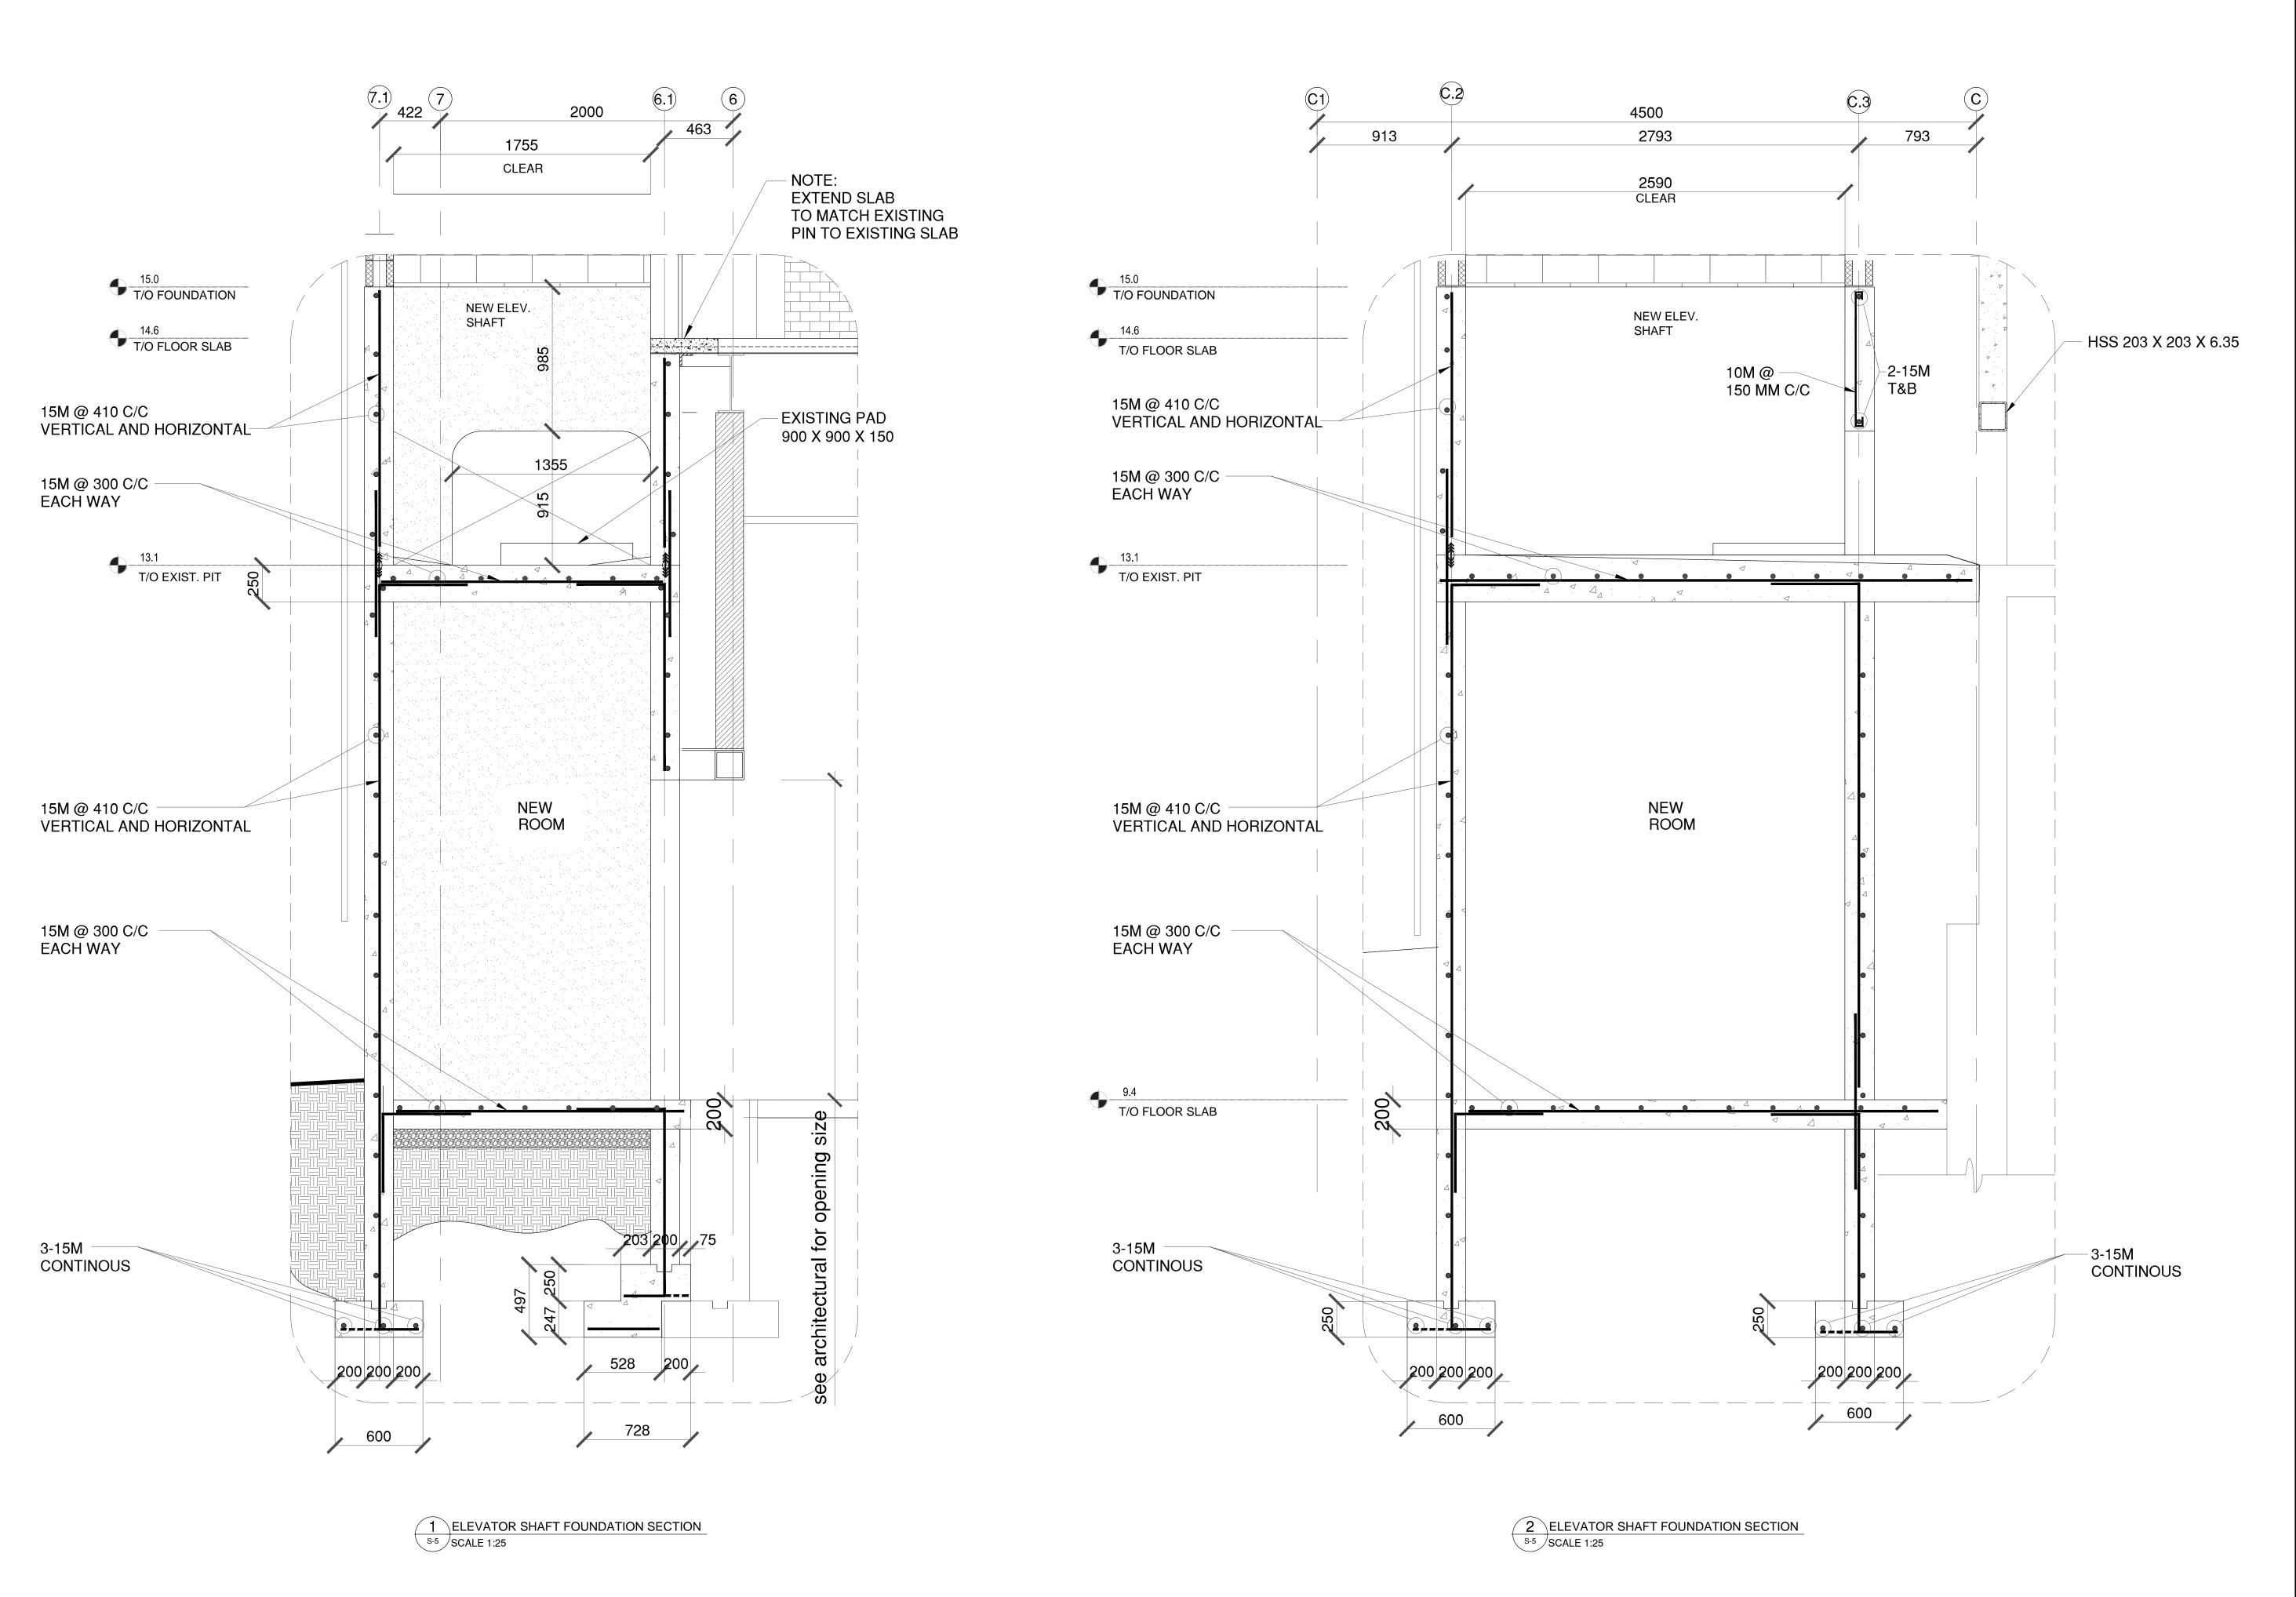






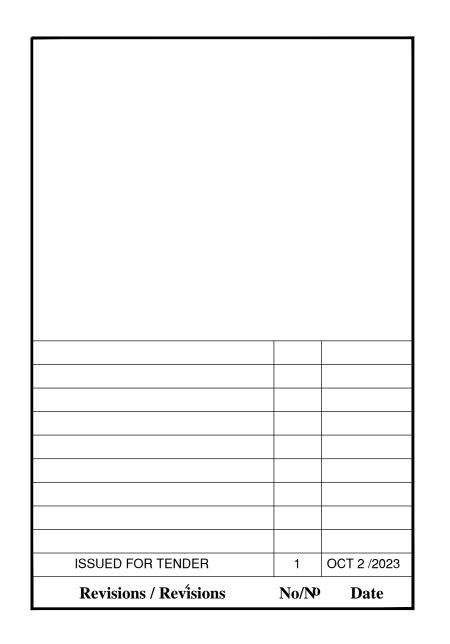


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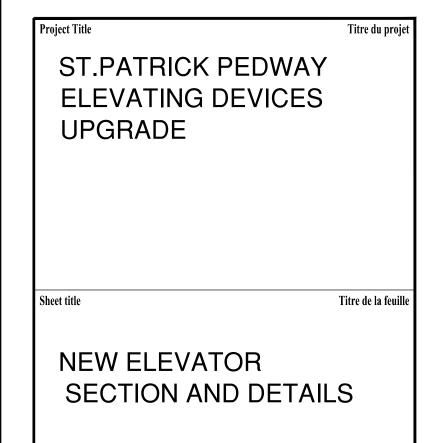


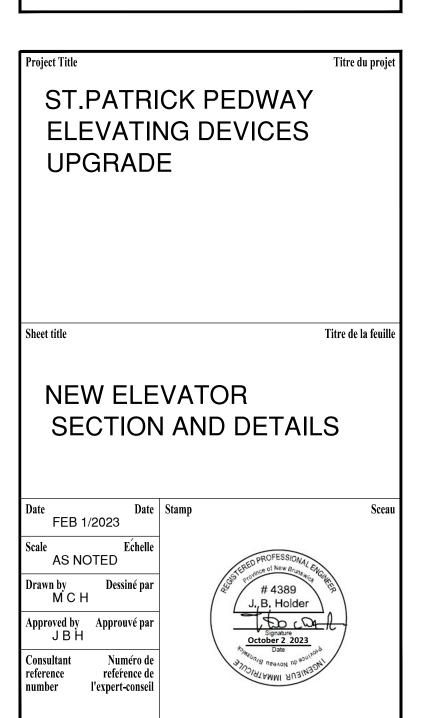





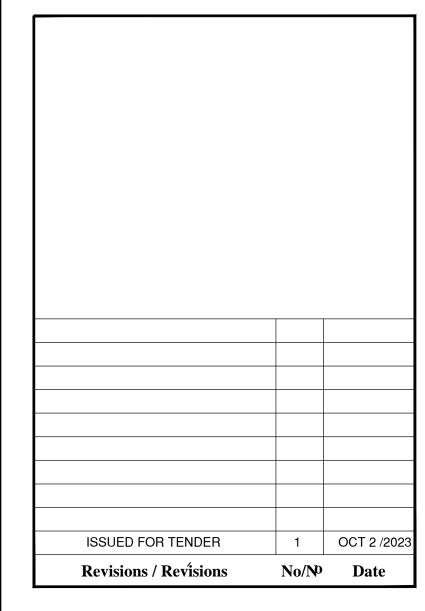




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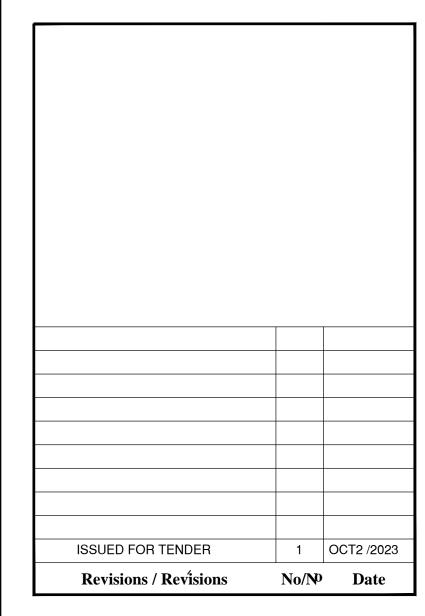
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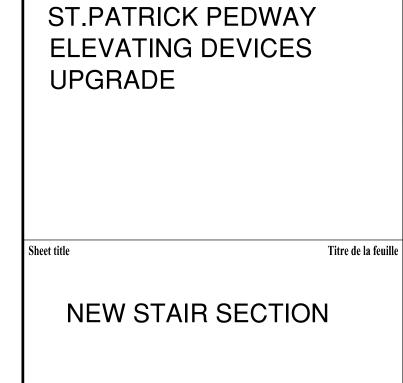






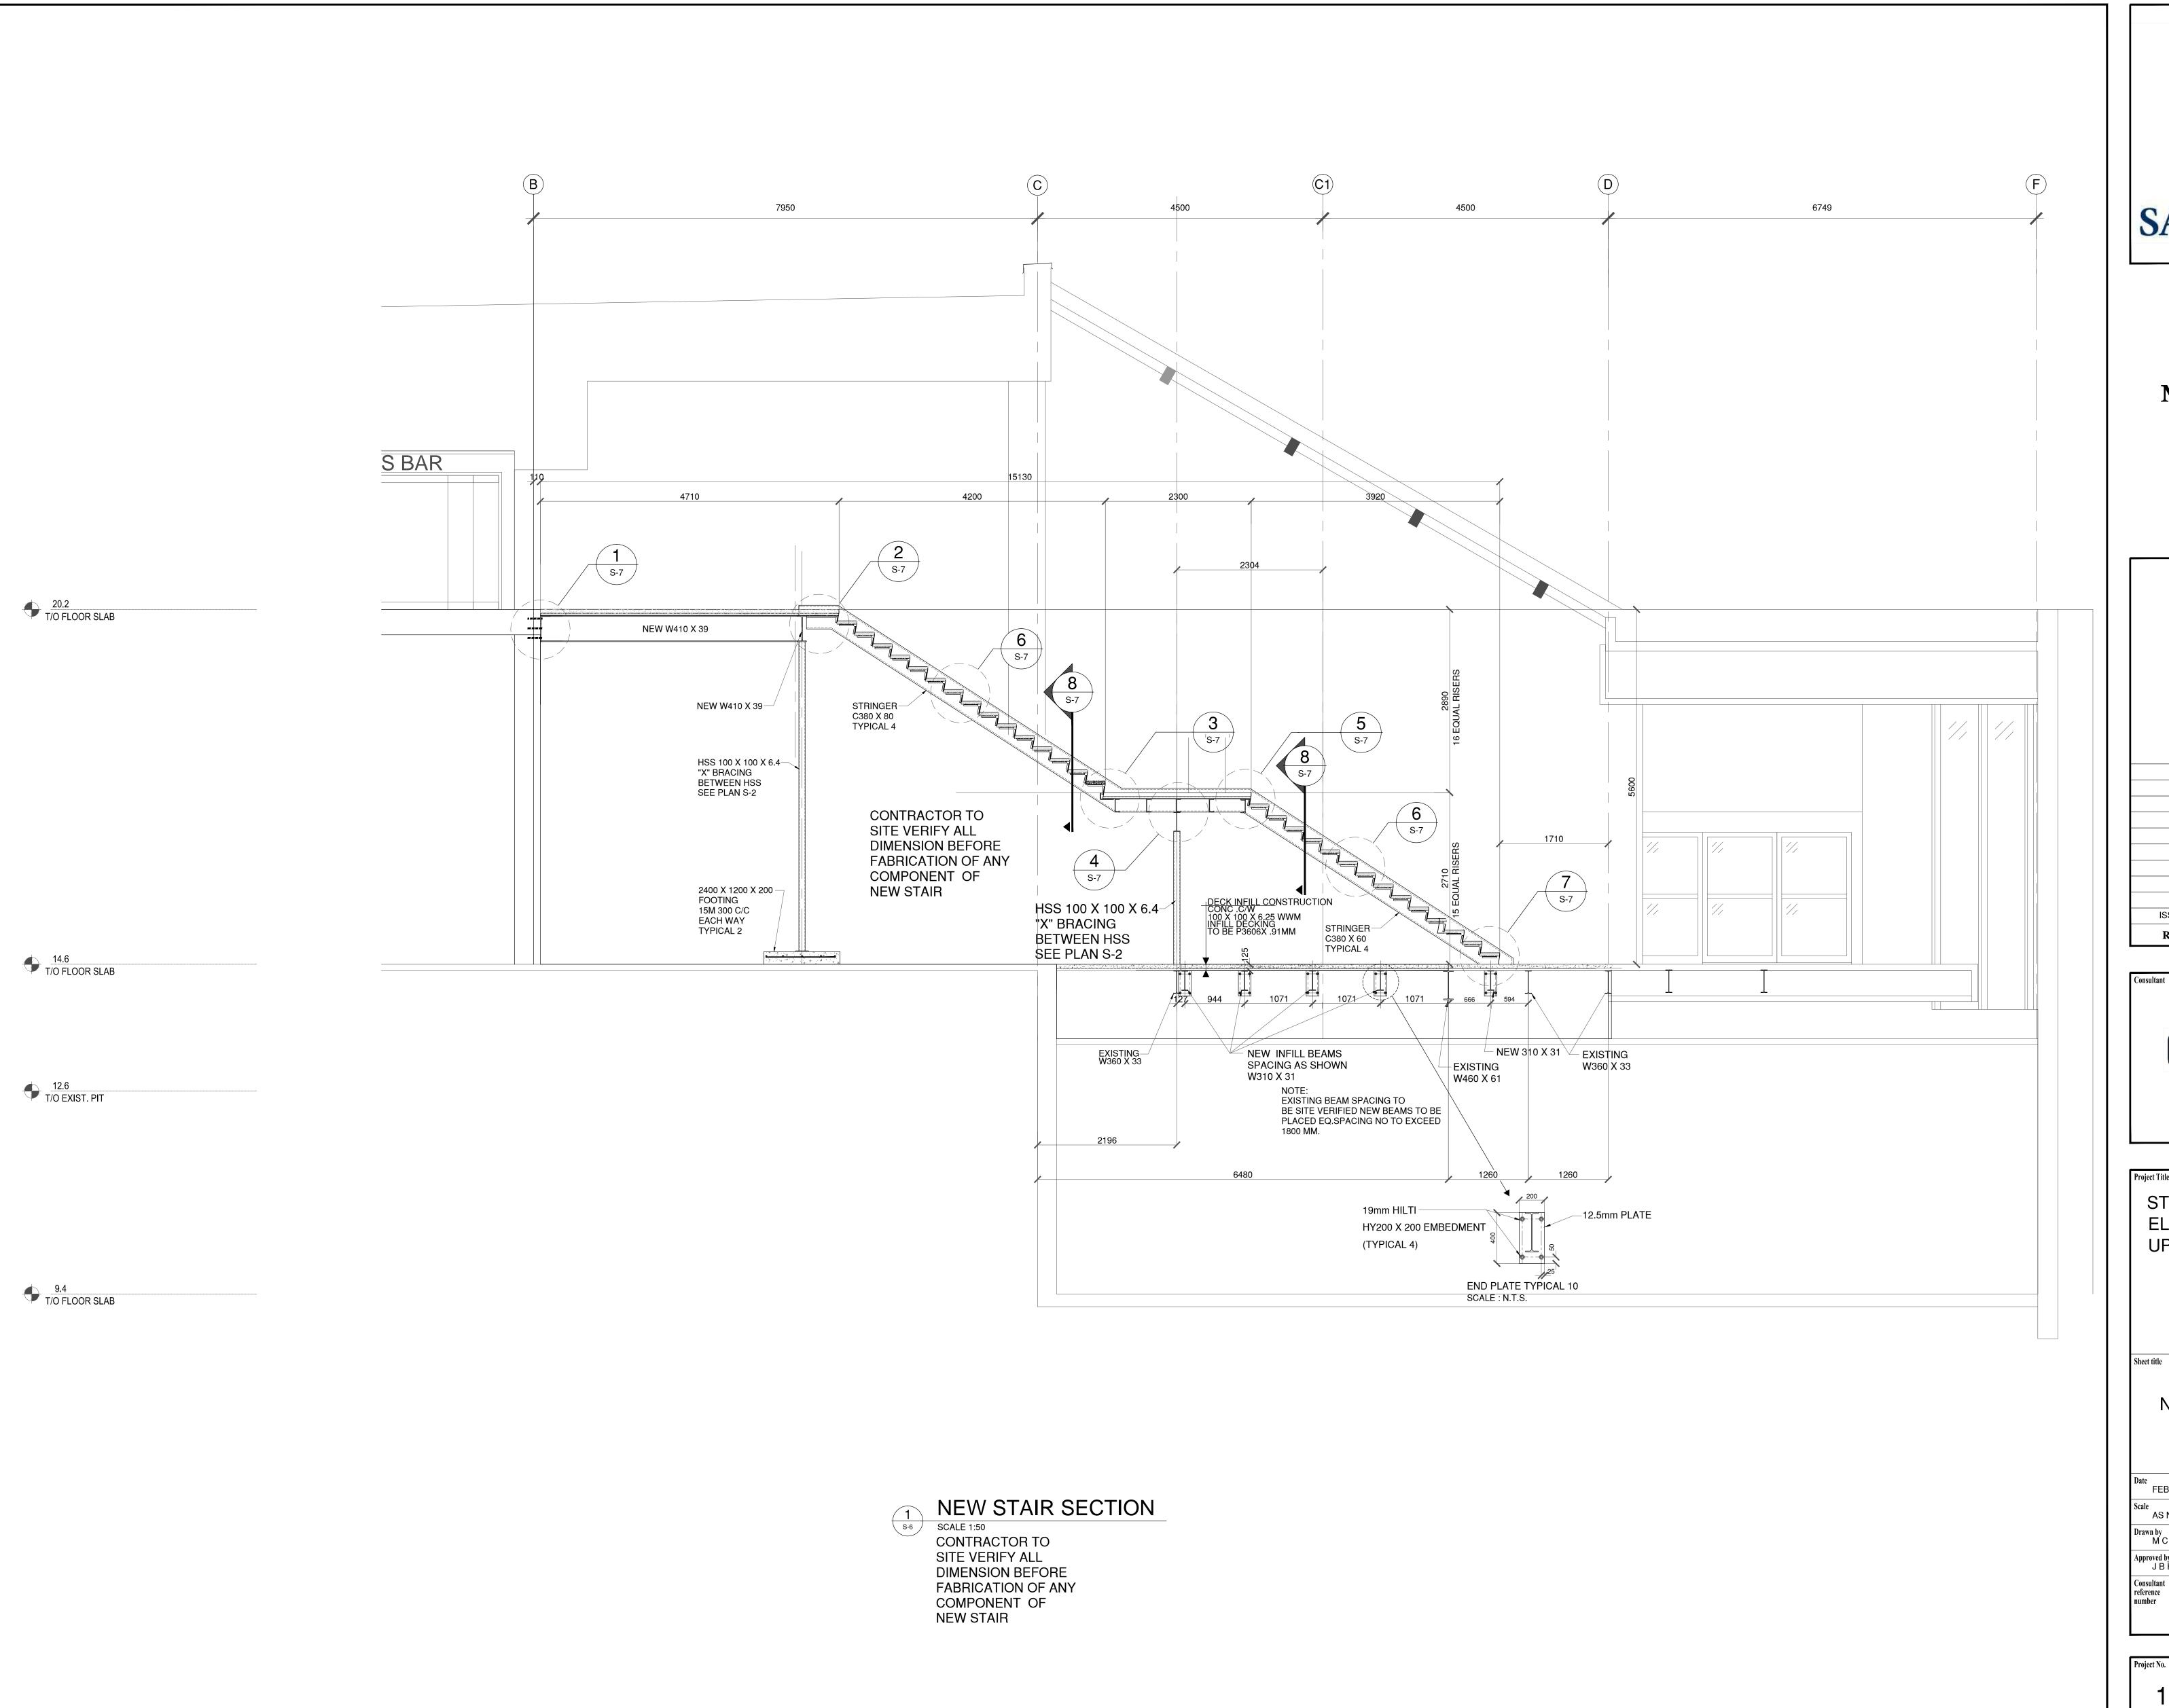





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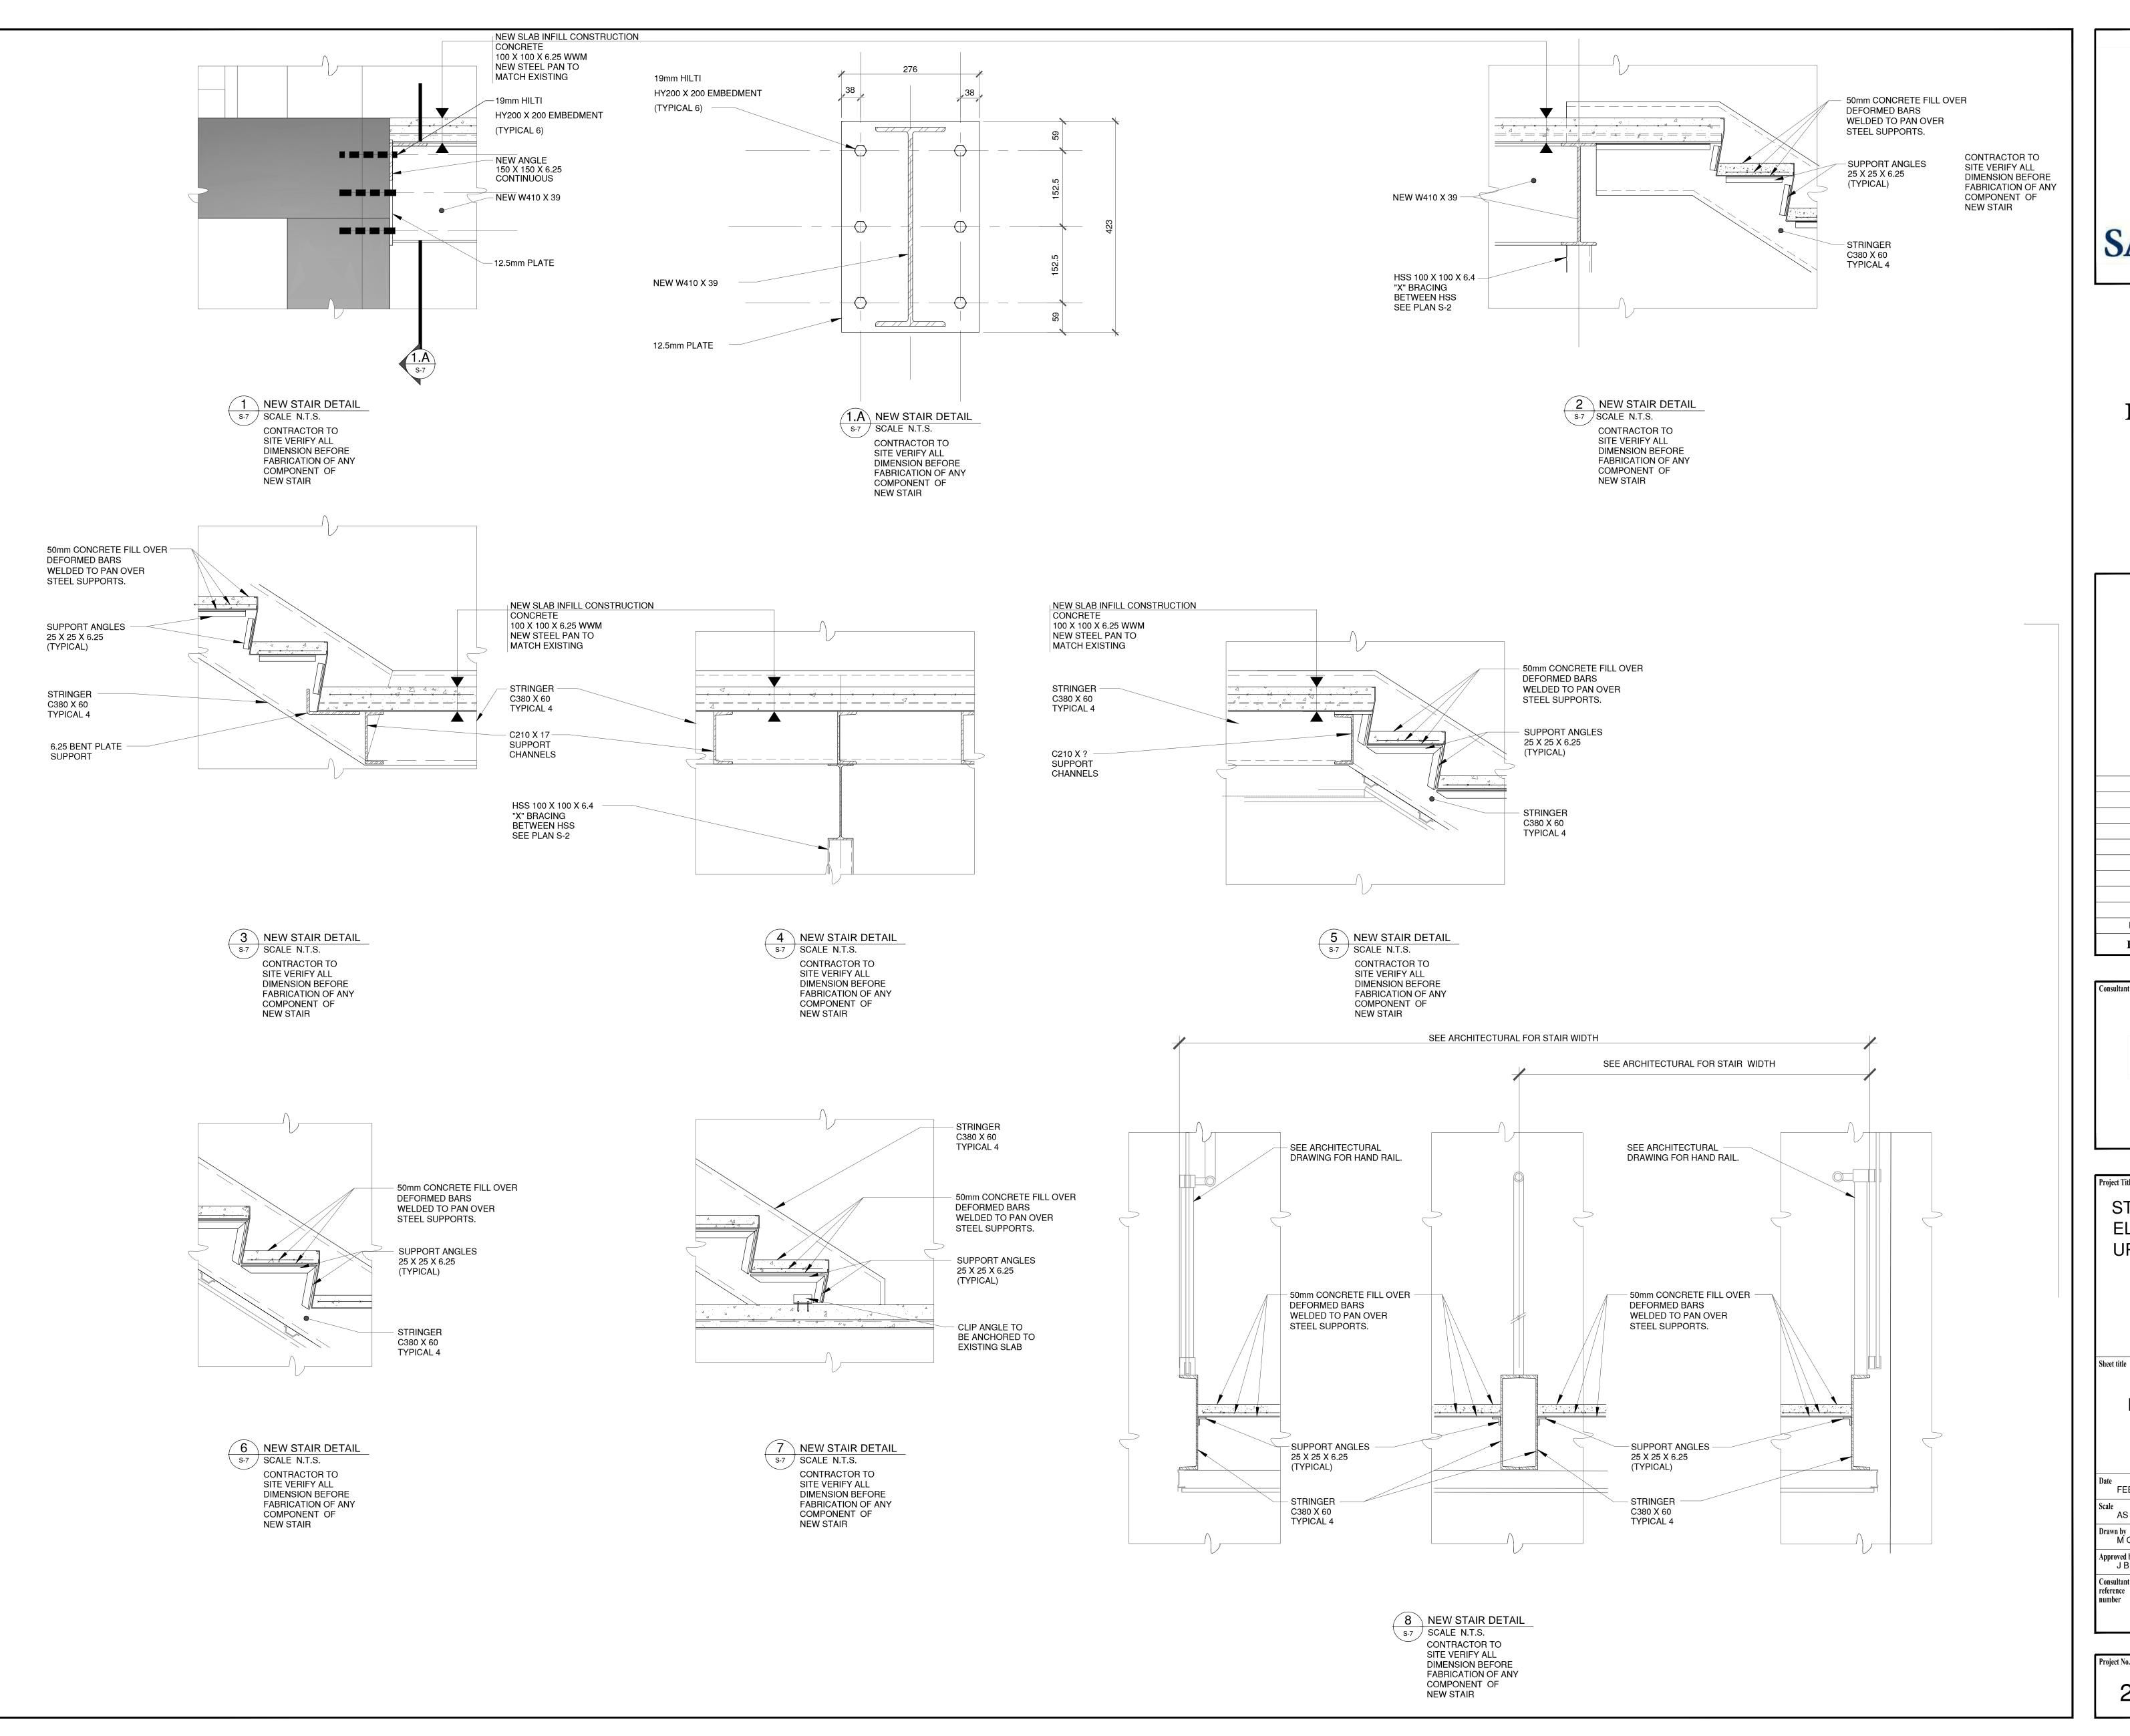
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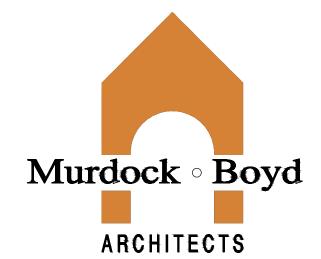
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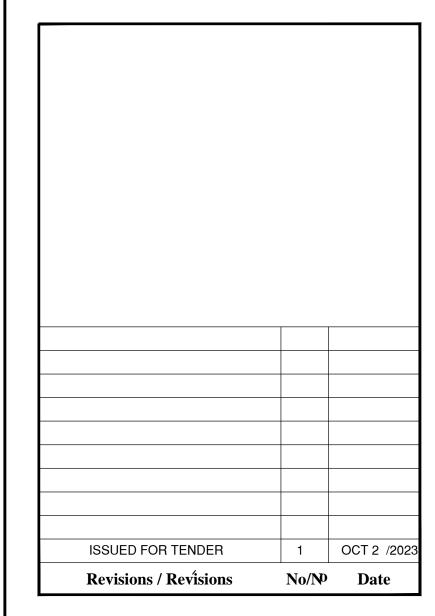
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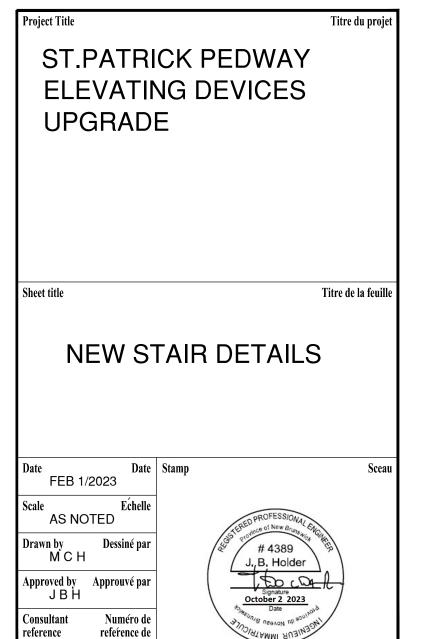












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l'expert-conseil

REFER TO ARCHITECTURAL DIMENSIONS, INSULATION REQUIREMENTS, CONTROL/EXPANSION JOINTS, AND DIMENSIONS (REPORT DISCREPANCIES IMMEDIATELY TO DESIGN TEAM). ADVISE ENGINEER IMMEDIATLEY OF ANY UNEXPECTED SITE CONDITIONS, DISCREPANCIES, OR SUBSTITUTIONS

CONTRACTOR IS RESPONSIBLE FOR TEMPORARY SHORING AND SUPPORT DURING CONSTRUCTION AND CONFORMANCE TO ALL WORKSAFE NB REGULATIONS AND GOVERNING STANDARDS.

CONTRACTOR IS RESPONSIBLE FOR CONCRETE QUALITY ASSURANCE AND IS TO SUBMIT STREGTH DISCREPANCIES TO ENGINEER FOR REVIEW.

ALL MEASUREMENTS TO BE FIELD CONFIRMED BY CONTRACTOR PRIOR TO FABRICATION.

SPECIFIED DESIGN LOADS ARE AS FOLLOWS:

ROOF DEAD LOAD 25 PSF ROOF SNOW LOAD 51 PSF FIRST/SECOND FLOOR DEAD 70 PSF FIRST/SECOND FLOOR LIVE 100 PSF

AND STAIRS

#### REINFORCED CONCRETE

ALL WORK SHALL COMPLY WITH CAN/CSA A23.1-09 (R2014) CONCRETE MATERIALS AND METHODS OF CONCRETE CONSTRUCTION CEMENT SHALL BE TYPE 10 NORMAL PORTLAND CEMENT.CONCRETE EXPOSURE CLASS AIR CONTENT.

SLABS, FOUNDATIONS CLASS

MINIMUM STRENGTH @ 28 DAYS TO BE

A. SLABS 35 MPA

B. FOOTINGS 25 MPA CLASS F-2

C WALLS 25 MPA CLASS F-2

NORMAL SIZE OF COARSE AGGREGATE TO BE 20 MM. MAXIMUM SLUMP SHALL BE 75mm (+/- 25mm

ADDITION OF WATER TO CONCRETE ON SITE NOT PERMITTED (APPROVED CONCRETE PLASTICIZER AS PER MANUFACTURERS INSTRUCTIONS TO INCREASE

SLUMPCONCRETE GENERAL CONTRACTOR IS REPSONSIBLE FOR COORDINATION OF ALL EMBEDDED ITEMS IN CONCRETE.

ADDITON OF UNSPECIFIED ADMIXTURERS SHALL NOT BE ADDED WITHOUT PRIOR APPROVAL OF THE ENGINEERPRIOR TO FABRICATION, SUBMIT SHOP & FIELD PLACEMENT DRAWINGS CLEARLY INDICATING SIZE AND SPACING OF BARS (ALLOW 1 WEEK FOR REVIEW).

LAP SPLICES SHALL MEET THE REQUIREMENTS OF A-23.3 FOR CLASS "C" SPLICES AND LAP A MINIMUM OF 30 BAR DIAMETERS OR 600 MM UNLESS NOTED OTHERWISE. FOUNDATION WALL REINFORCING SHALL BE CONTINUOUS AROUND CORNERS WITH HOOKED OR CORNER BARS AS SHOWN ON DRAWINGSSTEEL REINFORCEMENT TO

CONFORM TO G 30.12 GRADE 400.

PLACE STEEL REINFORCEMENT IN ACCORDANCE WITH CSA A23.1, 2 and 3.

ALL WALL CORNERS TO HAVE EACH LAYER LAPPED WITH CORNER HOOKS 30" EACH LEG FOR CONTINUITY.

ALL OPENINGS TO BE CUT IN EXISITNG CONCRETE TO BE FACILITATED WITH CIRCULAR CORING AT CORNERS - DO NOT OVERCUT.

SEE ARCHITECTURAL FOR CONTROL JOINTS - CUT SLAB THICKENESS DIVIDED BY 4 MINIMUM DEPTH

ALL NEW CONCRETE TO BE DOWELLED TO EXISTING CONCRETE WITH HILTI HY 200 AND 10 M DOWELS 32 INCHES LONG AT 16 " C/C.

#### MASONRY

ALL MASONRY WORK TO BE IN ACCORDANCE WITH CSA A179 04 (MORTAR AND GROUT FOR UNIT MASONRY), CSA A371 04 (MASONRY CONSTRUCTION FOR BUILDINGS), AND

CSA-S104.1-04 (MASONRY DESIGN FOR BUILDINGS).

SEE ARCHITECTURAL FOR CONTROL JOINT DESIGN AND LOCATION.

CONTRACTOR IS RESPONSIBLE FOR QUALITY ASSURANCE TESTING OF GROUT AND MORTAR.

ALL CONCRETE MASONRY WALLS TO BE FULLY GROUTED. MORTAR AND GROUT TO CONFORM TO CSA-A179-04.

MASONRY UNITS TO CONFORM TO CSA-A371-04 (R 2009).

PROVIDE REINFORCED BOND BEAMS OVER ALL MASONRY OPENINGS REINFORCED WITH ONE 15 M CHAIRED 25 MM ABOVE THE UNIT INSIDE BOTTOM

ALL MORTAR TO BE TYPE S.

SEE DRAWING S1 FOR CONCRETE MASONRY REINFORCING AND LATERAL SUPPORT

SEE ARCHITECTURAL SPECIFICATION FOR ADDITONAL DETAIL.

#### STRUCTURAL STEEL

STRUCTURAL STEEL SECTIONS SHALL BE NEW AND CONFORM TO THE FOLLOWING, IN ADDITION TO LATEST VERSION OF CSA S16.1:

A. FABRICATION, ERECTION, STRUCTURAL DESIGN, AND DETAILING OF ALL STEEL SHALL BE IN ACCORDANCE WITH AN/CSA-S16. WIDE FLANGE BEAMS AND WWF SECTIONS CSA G40.21 350W MISCELLANEOUS ROLLED SECTIONS (EXCEPT WIDE FLANGES) CSA G40.21 300W HOLLOW STRUCTURAL SECTIONS ASTM A500 GRADE C ROLLED PLATES CSA G40.21 300W BOLTS (SEE PLANS AND DETAILS) ASTM A325

STRUCTURAL STEEL ANCHOR RODS (U.N.O.) REINFORCING BAR ANCHOR BOLTS CAN/CSA-G30.18R, GRADE 400

#### FILLET WELDS SHALL BE 6 MM MINIMUM U.N.O.

BOLTS SHALL BE A325 20 MM Ø MINIMUM U.N.O.

BOLTED CONNECTIONS SHALL HAVE A MINIMUM OF TWO BOLTS IN EACH CONNECTED PIECE AND BE DESIGNED AS BEARING CONNECTIONS, U.N.O.

ALL WELDED HEADED STUDS AND WELDED DEFORMED BAR ANCHORS SHALL BE INSTALLED AS PER THE MANUFACTURERS SPECIFICATIONS AND RECOMMENDATIONS OR SHOP FILLET WELDED. ANY FIELD FILLET WELDED DEFORMED BARS OR STUDS WILL BE REJECTED. SEE PLANS, SECTIONS, DETAILS, AND SCHEDULES FOR LOCATIONS ETC., THE

ASTM A307

CONTRACTOR SHALL CO-ORDINATE THE DESIGN, SUPPLY, AND INSTALLATION OF ALL STUDS AND ANCHORS, INCLUDING, BUT NOT LIMITED TO STUDS AND DEFORMED BAR ANCHORS ON COMPOSITE BEAMS, DRAG STRUTS, EMBEDDED PLATES, AND ANY OTHER RELEVANT ITEMS.

UNLESS NOTED OTHERWISE, COLUMN CAP PLATES SHALL BE 16 MM THICK AND COLUMN BASE PLATES SHALL BE 20 MM MINIMUM THICK.

PROVIDE 6 MM CAP PLATES FOR ALL HSS MEMBERS UNLESS NOTED OTHERWISE.

CONNECTION DETAILS SHALL BE DEVELOPED AND STAMPED BY A REGISTERED PROFESSIONAL ENGINEER (NEW BRUNSWICK) AND SUBMITTED TO JB HOLDER ENGINEERING LTD FOR REVIEW.

CONNECTION DESIGN SHEAR TO BE FOR 50% OF THE MAXIMUM UNIFORMLY DISTRIBUTED LOAD IN A LATERALLY SUPPORTED CONDITON.

FRAME ROOF AND FLOOR OPENINGS GREATER THAN 450 MM IN ACCORDANCE WITH THE DETAILS IN THE GENERAL NOTES UNLESS NOTED OTHERWISE ON THE PLANS.

UNLESS NOTED OTHERWISE ON THE PLANS, REFER TO THE DETAILS IN THE GENERAL NOTES FOR FRAMING FOR SUPPORT OF ROOF TOP MECHANICAL EQUIPMENT.

STEEL TO BE EXPOSED IN FINISHED WORK SHALL BE CLEANED, PREPARED, PRIMED AND PAINTED IN ACCORDANCE WITH CSA STANDARD S16 AND THE ARCHITECTURAL

DRAWINGS AND PAINTING SPECIFICATION STONHARD CARBOGUARD 890 (2 COATS 4 MILS EACH COAT) AND 1 COAT OF CARBOTHANE 133 LH (2-3 MILS) COLOUR BY ARCHITECT.

ALL COATINGS TO BE REPAIRED ACCORDING TO MANUFACTURER INSTRUCTION

ALL STRUCTURAL STEEL OUTSIDE OF THE BUILDING ENVELOPE TO BE HOT DIPPED GALVANIZED UNLESS NOTED OTHERWISE.

DESIGN DRAWINGS INCLUDE ARCHITECTURAL, MECHANICAL, AND ELECTRICAL DRAWINGS. SEE ALSO ARCHITECTURAL DRAWINGS FOR ROOF AND FLOOR ELEVATIONS, ROOF SLOPES, EDGE DETAILS, AND ADDITIONAL DIMENSIONS AND DETAILS. WHERE ELEVATIONS, ROOF SLOPES, ETC., ARE SHOWN ON THE STRUCTURAL DRAWINGS, THEY MUST BE CONFIRMED WITH THE ARCHITECTURAL DRAWINGS.

UNLESS NOTED OTHERWISE, DO NOT OVERSIZE HOLES IN STEEL TO FIT ANY ANCHOR LOCATIONS. FOR COLUMN BASE PLATE HOLES, UNLESS NOTED OTHERWISE ON DRAWINGS, FOLLOW STANDARD PRACTICE WHICH IS TO USE SLIGHTLY OVERSIZED HOLES.

USE 6 MM OVERSIZED HOLE DIAMETER FOR COLUMN ANCHOR RODS UP TO AND INCLUDING

27 MM DIAMETER, AND 12 MM OVERSIZED HOLE DIAMETER FOR COLUMN ANCHOR RODS GREATER THAN 27 mm DIAMETER.

DEMOLITION ALL METAL DECK CONSTRUCTION TO CONFORM TO CSSBI 10 M OR CSSBI 12 M.

ALL ROOF DECK TO BE CANAM 38 MM P3606 X 18 GAUGE OR APPROVED EQUAL.

ALL FLOOR DECK TO BE CANAM 76 MM LF3 X 18 GAUGE OR APPROVED EQUAL.

ALL SIDE LAPS TO BE SELF DRILLING SCREWS AT 12 INCHES C/C, MINIMUM.

ALL DECK TO BE FASTENED TO STEEL AS FOLLOWS:


FLOOR 4" NELSON STUD 3/4 AT 1200 MM MAXIMUM

ALL ADHESISVE ANCHORS TO BE HILTI HY200 WITH B7 RODS - 3/4 MINIMUM

ROOF 3/4 PUDDLE WELD OR SELF DRILLING SCREWS AT 12" C/C





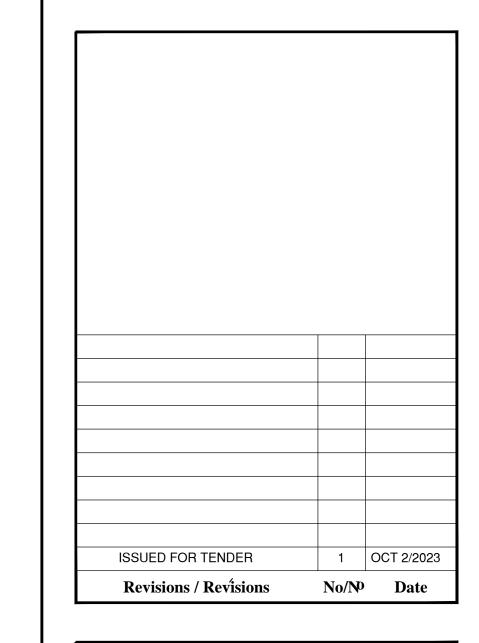



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| STRUCT        | TURAL NOTES            |

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Approved by Approuvé par

reference de l'expert-conseil